


MASON FARMS III CRE BRIDGE LOAN FUND, LLC

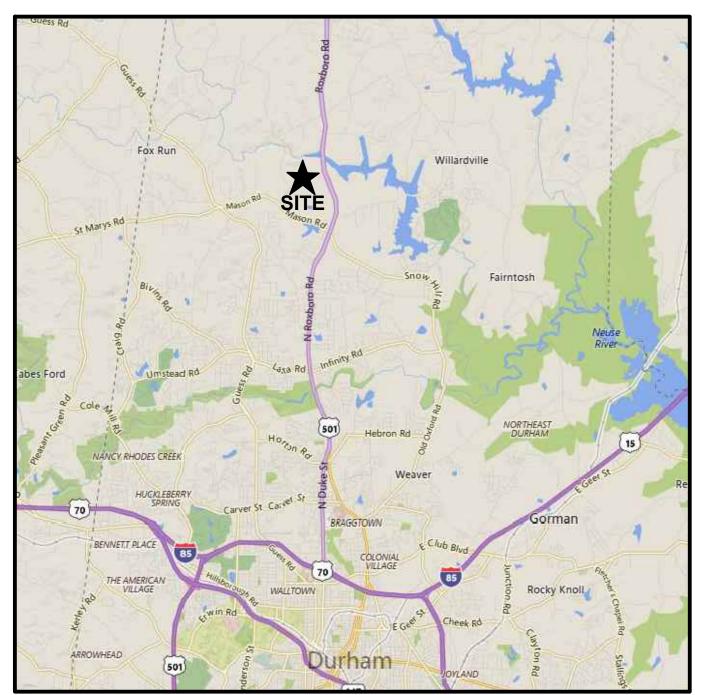

VICINITY MAP

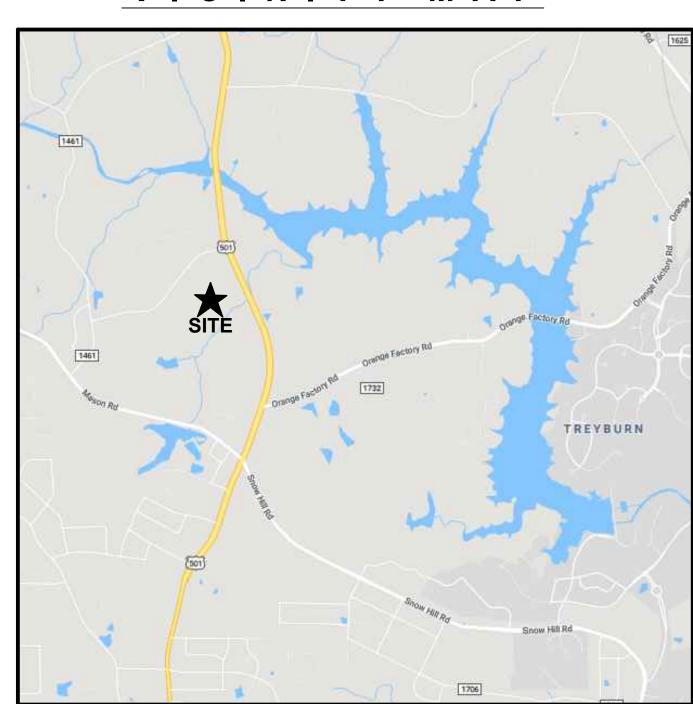

LOCATION MAP

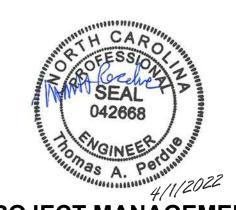

PROJECT MANAGEMENT

MAJOR SITE PLAN CASE# D2100325

7001 N ROXBORO RD **DURHAM, NC 27712**

PROJECT No. A90101.00

SCHEDULE OF DRAWINGS

DRAWINGS	SITE SUMMAR'	Y INFORMATION
SHEET		
T SURVEY - 1	PRESENT OWNER:	III CREDIT SPV LLC

	COVER SHEET			9
\B-1	AS-BUILT SURVEY - 1	PRESENT OWNER:	III CREDIT SPV LLC	T
		TRESERVI OWNER.	III ONEDIT SI V EEG	S
AB-2	AS-BUILT SURVEY - 2		III CAPITAL MANAGEMENT & AVM LP	1
AB-3	AS-BUILT SURVEY - 3		777 YAMATO RD.	
AB-4	AS-BUILT SURVEY - 4		SUITE 300 BOCA RATON, FL 33431	1
\B-5	AS-BUILT SURVEY - 5		(561) 544–4633	4
\B-6	AS-BUILT SURVEY - 6		BRANDON.PELLEGRINO@AVMLTD.COM	1:
AB-7	AS-BUILT SURVEY - 7			
AB-8	AS-BUILT SURVEY - 8	ZONING: DEVELOPMENT TIER:	RR (RURAL RESIDENTIAL) RURAL	13
S-1	TREE SURVEY - 1	WATERSHED OVERLAY DISTRICT:	M/LR-A	
S-2	TREE SURVEY - 2	OVERLAY DISTRICT:	NONE	
S-3	TREE SURVEY - 3	RIVER BASIN:	NEUSE	
;-100	ADJACENT PROPERTY OWNERS	CURRENT USE:	RESIDENTIAL/VACANT	
G-101	EXISTING CONDITIONS	PROPOSED USE: TOTAL SITE AREA:	RESIDENTIAL 287.723 AC	
-102 -102	EXISTING STORMWATER	DEVELOPMENT DENSITY:	141 UNITS (.5 UNITS PER ACRE)	
-102	STRUCTURES	CURRENT IMPERVIOUS:	1.89 AC `	
102		PROPOSED IMPERVIOUS:	14.87 AC	
-103	SITE ANALYSIS - 1	ZONING:	RR, M/LR—A	4
-104	SITE ANALYSIS - 2	DENSITY ALLOWED: PROPOSED DENSITY:	.5 DU/AC .49 DU/AC	10
:-105	OVERALL SITE PLAN	PROPOSED LOTS:	142	1
:-106	NORTHEAST SITE PLAN	NO MINIMUM LOT SIZE OR WIDTH REQUIR		18
-107	SOUTHWEST SITE PLAN	MINIMUM LOT WIDTH PROVIDED:	50'	
-108	GRADING PLAN	MINIMUM LOT SIZE PROVIDED:	5,900 SF	19
:-109	LANDSCAPE PLAN	HOUSING TYPE: MAX BUILDING HEIGHT:	SINGLE FAMILY DETACHED 35'	
-110	LANDSCAPE / LIGHTING PLAN	MAX ALLOWABLE IMPERVIOUS SURFACE:	17.28 AC (6%)	
-111	WATER SUPPLY AND	EXISTING IMPERVIOUS SURFACE:	1.82 AC (1%)	2
	WASTEWATER PLAN	PROPOSED IMPERVIOUS SURFACE:	14.87 AC (5.2%)	2 2 2
:-112	PREDEVELOPMENT STORMWATER	REQUIRED BUILDING SETBACKS:	0,1	2
	DRAINAGE AREAS	FRONT: REAR:	8' 50'	2
:-113	POSTDEVELOPMENT STORMWATER		10' BUILDING SEPARATION	2
7-113	DRAINAGE AREAS		TO BOILDING SELFMANION	_
. 444		REQUIRED OPEN SPACE FOR CONSERVATI	ION SUBDIVISION: 50% (143.86 AC)	
:-114	POSTCONSTRUCTION STORMWATER	PROVIDED OPEN SPACE (100% PRIMARY	CONSERVATION): 50.45% (145.15 AC)	
	STRUCTURES			

0826-85-19-0120

0826-76-80-8942

0826-86-00-4942

PIN's OF ALL PROPERTIES

0826-76-71-8368

0826-86-14-9766

0826-66-46-3077

0826-75-98-9032





PROJECT ENGINEER

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0826-75-24-858

0826-75-35-8006 0826-75-45-8403

MacCONNELL & Associates, P. C.

501 CASCADE POINTE LANE, SUITE 103 CARY, NORTH CAROLINA 27513 P. O. BOX 129

MORRISVILLE, NORTH CAROLINA 27560 TEL: (919) 467-1239 FAX: (919) 319-6510

GENERAL CONDITIONS OF APPROVAL

- 1. ALL PROPOSED AND FUTURE DEVELOPMENT WITHIN THE FLOODWAY OR NON-ENCROACHMENT AREA OR FLOODWAY FRINGE AND NON-ENCROACHMENT AREA FRINGE, INCLUDING FILL, NEW CONSTRUCTION, SUBSTANTIAL IMPROVEMENTS, MANUFACTURED HOUSING, STORAGE OF MATERIALS AND STORAGE OF TOXIC OR FLAMMABLE SUBSTANCES, IS PROHIBITED EXCEPT AS PROVIDED BY APPLICABLE FLOOD HAZARD REGULATIONS OF UDO SECTION 3.22 AND 8.4. FEMA MAP NUMBER: 3720082600k
- FEMA MAP DATE: OCTOBER 19, 2018 KNOWN FLOOD SOURCES: LITTLE RIVER TRIBUTARY 4, BFE(S) FOR: 1% ANNUAL CHANCE OF FLOODING: 421.8, 412.4, 408.1 FUTURE 1% ANNUAL CHANCE OF FLOODING: 422.0, 412.7, 408.6
- AUTHORIZATION MAY RESULT IN THE NEED FOR A SITE PLAN AMENDMENT OR A NEW SITE PLAN BASED ON THE SCOPE OF THE REQUIRED CHANGES. IF A SITE PLAN AMENDMENT OR NEW SITE PLAN IS REQUIRED, IT MUST BE APPROVED PRIOR TO CONSTRUCTION DRAWING APPROVAL. CONTACT THE DURHAM CITY—COUNTY PLANNING DEPARTMENT AT 919—560—4137 TO DETERMINE IF A SITE PLAN AMENDMENT OR A NEW SITE PLAN WILL BE REQUIRED. 150-FOOT WIDE UNDISTURBED STREAM BUFFER, MEASURED FROM TOP OF BANK, EACH SIDE OF STREAM. NO CLEARING OR GRADING OTHER THAN SELECTIVE THINNING AND ORDINARY MAINTENANCE OF EXISTING VEGETATION PERMITTED, EXCEPT IN ACCORDANCE WITH 15A NCAC 02B.0714(11), VEGETATION MANAGEMENT. NO STRUCTURES OR FEATURES REQUIRING GRADING OR CONSTRUCTION MAY BE BUILT WITHIN THE 10-FOOT STREAM BUFFER SETBACK. ANY USE ALLOWED BY SECTION 8.5.5 (THE UDO SHALL BE DESIGNED AND CONSTRUCTED TO MINIMIZE THE AMOUNT OF INTRUSION INTO THE STREAM BUFFER AND TO MINIMIZE CLEARING, GRADING, EROSION AND WATER QUALITY DEGRADATION, (UDO SECTION 8.5)
- STATE AND FEDERAL PERMIT AUTHORIZATION MAY BE REQUIRED FROM THE NC DEQ, NC DWR, AND THE U.S. ARMY CORPS OF ENGINEERS PRIOR TO THE COMMENCEMENT OF ANY LAND DISTURBING ACTIVITIES IN OR NEAR Á LAKE TRIBUTARY, OR ANY UNNAMED BODY OF WATER AND ITS ADJACENT WETLANDS. (UDO SECTION 8.9)
 ALL SITE IMPROVEMENTS, INCLUDING LANDSCAPING, MUST BE IN PLACE PRIOR TO THE ISSUANCE OF A CERTIFICATE OF COMPLIANCE. CONTACT THE DURHAM CITY—COUNTY PLANNING DEPARTMENT SITE COMPLIANCE STAFF TO SCHEDULE AN INSPECTION
- DURHAM CITY—COUNTY PLANNING DEPARTMENT SITE COMPLIANCE STAFF WHEN SCHEDULING A SITE COMPLIANCE INSPECTION.
 - RED AND HOLE PREPARATION: A. TREATMENT WAS ADDED ONLY PER RECOMMENDATIONS. BASED ON SOIL TESTS: SOIL TEST RESULTS ARE ATTACHED. IF APPLICABLE TREE HOLES AND PLANTING BEDS HAVE BEEN TESTED FOR INFILTRATION
 - THERE WAS NO LANDSCAPE FABRIC USED ON SITE
 - THE ROOT COLLAR OF ALL TREES HAS BEEN EXPOSED AND IS FREE FROM SOIL, DEBRIS AND MULCH
 - A. TREES ARE INSTALLED WITH ROOT COLLARS EXPOSED AND COMPLETELY ABOVE GRADE B. TREES AND PLANTS WERE WATERED WITHIN TWO DAYS OF INSTALLATION
 - . MULCH HAS BEEN INSTALLED WITHIN A WEEK OF INSTALLATION TREES HAVE BEEN VERIFIED TO BE THE SAME SPECIES AND CULTIVAR AS LISTED ON PLANS. ANY SUBSTITUTIONS, (IN ACCORDANCE WITH THE LANDSCAPE MANUAL), IF APPLICABLE, ARE ATTACHED. RESULTS OF SOIL TESTS FOR EACH AREA OF DIFFERENT VEGETATION INSTALLATION, IF APPLICABLE, ARE ATTACHED
- . RATES OF CHEMICAL MODIFICATIONS (TO PH AND FERTILITY ADJUSTMENTS), IF APPLICABLE, ARE ATTACHED
- A. PRESERVED TREE COVERAGE AREAS SHALL NOT BE USED FOR ACTIVE RECREATIONAL PURPOSES, EXCEPT FOR UNPAVED WALKING PATHS AND FOOT TRAILS CONSTRUCTED WITH MINIMAL DISTURBANCE OF TREE EIGHT INCHES OR GREATER SHALL BE REMOVED FOR THE CONSTRUCTION OF TRAILS. SITE PLAN APPROVAL IS REQUIRED FOR CONSTRUCTION OF TRAILS IN PRESERVED TREE COVERAGE AREAS. B. ALL BUILDINGS, UTILITIES, AND STORMWATER FACILITIES SHALL BE SET BACK AT LEAST 10 FEET FROM THE EDGE OF ANY PRESERVED TREE COVERAGE AREA. NO EASEMENTS, EXCEPT
- GRADING PERMIT. SUCH FENCING SHALL BE MOUNTED ON METAL POSTS PLACED NO FURTHER THAN 10 FEET APART. SILT FENCING SHALL NOT SERVE AS TREE PROTECTION FENCING. WARNING SIGNS SHALL BE POSTED AT EACH END OF THE TREE PROTECTION FENCE WITH PERIMETER SIGNS SPACED A MAXIMUM OF 100 FEET ON CENTER THEREAFTER. EACH SIGN SHALL READ: "NO TRESPASSING/TREE PROTECTION AREA" AND "PROHIBIDO ENTRAR / ZONA PROTECTORA PARA LOS ÁRBOLES." 11. ROOT PROTECTION ZONE (UDO SECTION 8.3): SHALL BE ESTABLISHED AROUND ALL TREES TO BE PRESERVED. THE ROOT PROTECTION ZONE SHALL EITHER BE A SIX-FOOT RADIUS AROUND A TREE OR ONE FOOT OF RADIUS FOR EVERY INCH OF DIAMETER AT BREAST HEIGHT (DBH) OF EXISTING TREES, WHICHEVER IS GREATER.
- THE START OF GRADING INVOLVING THE LOWERING OF EXISTING GRADE AROUND A TREE OR STRIPPING OF TOPSOIL, A CLEAN, SHARP, VERTICAL CUT SHALL BE MADE AT THE EDGE OF THE OTHER EROSION CONTROL MEASURES ARE INSTALLED. THE TREE PROTECTION FENCING SHALL BE INSTALLED ON THE SIDE OF THIS CUT FARTHEST AWAY FROM THE TREE TRUNK AND SHALL REMAIN IN PLACE UNTIL ALL CONSTRUCTION IN THE VICINIT
- 13. UDO SITE LIGHTING NOTE (UDO SECTION 7.4): LEVELS SHALL APPLY ONLY TO THE EXTERIOR LOT LINES OF THE PROJECT (ANY INTERIOR LOT LINES SHALL BE EXEMPT FROM THIS PARAGRAPH). THE MAXIMUM ILLUMINATION AT THE EDGE OF THE PROPERTY LINE ADJACENT TO A RESIDENTIAL ZONING DISTRICT IS 0.5 FOOT-CANDLES. FORM 6399, APRIL 2021 PAGE 4 OF 9
- THE MAXIMUM ILLUMINATION AT THE EDGE OF THE PROPERTY LINE ADJACENT TO A NONRESIDENTIAL ZONING DISTRICT IS 5.0 FOOTCANDLES. THE MAXIMUM ILLUMINATION AT THE EDGE OF THE PROPERTY LINE ADJACENT TO A STREET IS 5.0 FOOT-CANDLES.
- THE MAXIMUM HEIGHT FOR DIRECTIONAL OR FULL CUT-OFF LIGHTING FIXTURES (FIXTURES DESIGNED TO INSURE THAT NO LIGHT IS EMITTED ABOVE A HORIZONTAL LINE PARALLEL TO THE GROUND) SHALL BE 30 FEET ABOVE GRADE D. THE MAXIMUM HEIGHT FOR NON-DIRECTIONAL LIGHTING FIXTURES, WHICH ARE DEFINED AS FIXTURES DESIGNED TO ALLOW LIGHT TO BE EMITTED ABOVE A HORIZONTAL LINE PARALLEL TO THE GROUND, SHALL BE 15 FEET ABOVE GRADE.
- NON-DIRECTIONAL LIGHTING FIXTURES SHALL BE TRANSLUCENT OR HAVE BAFFLES TO PREVENT VIEWS OF THE LIGHT SOURCE. E. UNDER-CANOPY LIGHTING SHALL BE RESTRICTED TO LIGHTING FIXTURES (INCLUDING LENSES) THAT DO NOT PROJECT BELOW THE BOTTOM OF THE CANOPY LIGHTING SHALL BE ORIENTED NOT TO DIRECT GLARE OR EXCESSIVE ILLUMINATION ONTO STŔEETS IN A MANNER THAT MAY DISTRACT OR INTERFERE WITH THE VISION OF DRIVERS ON SUCH STREETS.
- G. THESE STANDARDS MUST BE VERIFIED BY FIELD SURVEY (BY USE OF PHOTOMETRIC SURVEY) PRIOR TO THE CERTIFICATE OF COMPLIANCE BEING ISSUED. ALL OF THIS INFORMATION, INCLUDING DETAILS, WILL BE REQUIRED ON BUILDING PLANS PRIOR 17. COUNTY STORM OR PRIVATE DRAINAGE EASEMENTS: CENTERLINE OF 10 FOOT WIDE DRAINAGE EASEMENT FOR THE BENEFIT OF ADJACENT PROPERTY OWNERS NOT MAINTAINED BY PUBLIC AUTHORITIES. NO BUILDINGS, STRUCTURES, FILLS, EMBANKMENTS OR OBSTRUCTIONS PERMITTED WITHIN THE EASEMENT EXCEPT ACCORDING TO THOSE TERMS 18. FOR RESIDENTIAL DEVELOPMENTS USING CURBSIDE COLLECTION: AN AUTOMATED SOLID WASTE COLLECTION VEHICLE HAS AN 18-FOOT WHEELBASE AND A TURNING RADIUS OF 45 FEET WALL-TO-WALL AND 43 FEET CURB-TO-CURB. THE DEPARTMEN OF SOLID WASTE MANAGEMENT RESERVES THE RIGHT TO MODIFY COLLECTION OF GARBAGE AND RECYCLABLES FOR ANY ROADWAY OR CUL-DE-SAC NOT CONSTRUCTED TO ACCOMMODATE THOSE SPECIFICATIONS.
- 19. SAFEGUARDS DURING THE CONSTRUCTION, ALTERATION, OR DEMOLITION OF STRUCTURES SHOWN ON THIS SITE PLAN SHALL BE IN ACCORDANCE WITH CHAPTER 33 OF THE 2018 NORTH CAROLINA FIRE CODE AND NFPA241 (2013 EDITION). A. SEDIMENTATION AND EROSION CONTROL PLAN MUST BE SUBMITTED AND APPROVED PRIOR TO THE ISSUANCE OF A LAND-DISTURBANCE PERMIT. B. IF AN OFFSITE SOIL SPOIL OR BORROW SITE IS UTILIZED, THEN THE DISTURBED AREA FOR THE SPOIL/BORROW SITE MUST BE INCLUDED IN THE LAND-DISTURBANCE PLAN AND PERMIT UNLESS THE SPOIL/BORROW SITE ALREADY HAS A
- 1.CART COLLECTIONS FOR SOLID WASTE WILL BE DONE BY PRIVATE COMMERCIAL VENDOR. SOLID WASTE CONTAINMENT CAPACITY AND COLLECTION FREQUENCY WILL BE SUFFICIENT TO PREVENT THE ILLEAGAL PLACEMENT OF TRASH AND RECYCLEABLES. 22. A LAND-DISTURBING PERMIT WILL BE REQUIRED PRIOR TO THE COMMENCEMENT OF ANY LAND-DISTURBING ACTIVITY.

 23. A SEDIMENTATION AND EROSION CONTROL PLAN MUST BE SUBMITTED PRIOR TO THE ISSUANCE OF ANY LAND-DISTURBING PERMIT 24.IF TREE PROTECTION IS REQUIRED BY THE CITY/COUNTY PLANNING DEPARTMENT. TREE PROTECTION CERTIFICATION MUST BE SUBMITTED TO THE DURHAM COUNTY EROSION CONTROL DIVISION, AND TREE PROTECTION INSPECTION COMPLETED PRIOR TO
- THE ISSUANCE OF LAND DISTURBANCE PERMIT 25. IF AN OFFSITE SPOIL OR BORROW PIT IS UTILIZED, THEN THE DISTURBED AREA FOR THE SPOIL/BORROW SITE MUST BE INCLUDED IN THE LAND-DISTURBANCE PERMIT UNLESS THE SPOIL/BORROW SITE ALREADY HAS A LAND-DISTURBING PERMIT. 26.A CONSTRUCTION STORMWATER PERMIT WILL BE REQUIRED TO BE OBTAINED FROM DURHAM COUNTY PRIOR TO ANY DISTURBANCE BEGINING ON SITE. 27.AN OPERATIONAL STORMWATER PERMIT WILL BE REQUIRED TO BE OBTAINED AT THE CONCLUSION OF CONSTRUCTION.


SPECIAL CONDITIONS OF APPROVAL

- ELLIGLIBLE FOR PUBLIC ACCEPTANCE. STREETS OUTSIDE THE CORPORATE LIMITS MUST REQUEST NCDOT MAINTENANCE AS SOON AS THE NCDOT OCCUPANCY REQUIREMENT IS MET, AND NOT MORE THAN TWICE THE MINIMUM NUMBER OF UNITS REQUIRED BY MAINTENANCE BY NCDOT MAY BE OCCUPIED PRIOR TO ACCEMPTANCE FOR
- THE DEVELOPER (OR HIS/HER SUCCESSOR) SHALL PROVIDE AND MAINTAIN CATASTROPHIC PROPERTY INSURANCE TO COVER 100% OF THE REPLACEMENT COST OF THE WASTEWATER SYSTEM.

SEPTEMBER 21, 2021			
	REVISIONS		
NO.	DATE	TE DESCRIPTION SHEET	
1	12/13/21	REVISED PER DURHAM COMMENTS	ALL
2	02/01/22	REVISED PER DURHAM COMMENTS	ALL
3	4/1/22	PER NCDOT COMMENTS	ALL

CASE NUMBER: D2100325

STAMPING AREA

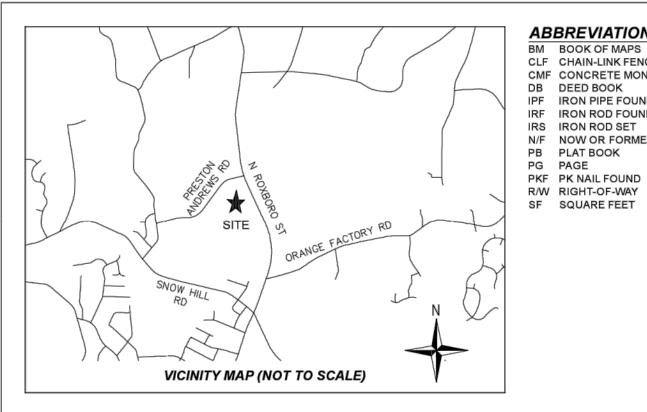

ABBREVIATIONS BM BOOK OF MAPS CLF CHAIN-LINK FENCE

DB DEED BOOK IPF IRON PIPE FOUND IRF IRON ROD FOUND IRS IRON ROD SET N/F NOW OR FORMERLY PB PLAT BOOK

R/W RIGHT-OF-WAY SF SQUARE FEET

GENERAL NOTES

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- 2) LOT LINES SHOWN ARE SOLEY BASED ON DURHAM GIS AND HAVE NOT BEEN SURVEYED OR CONFIRMED. THEY ARE SHOWN FOR REFERENCE ONLY.
- 3) PROPERTIES SHOWN HEREON ARE SUBJECT TO EASEMENTS AND RESTRICTIONS OF RECORD THAT WOULD BE REVEALED BY A THOROUGH TITLE SEARCH. THIS PLAT SHOULD NOT BE RELIED UPON AS A COMPLETE RECORD OF ALL EASEMENTS THAT MAY EFFECT THESE PROPERTIES.
- 4) THIS MAP DOES NOT REPRESENT A BOUNDARY SURVEY. PROPERTY LINES, STREAM CENTERLINES AND PLANIMETRIC INFORMATION SHOWN HEREON WERE TAKEN FROM CAD FILES PROVIDED BY THE CLIENT; AND THIS INFORMATION HAS BEEN SHOWN HEREON FOR REFERENCE PURPOSES ONLY. NO TRANSLATION, ROTATION OR SCALING WAS PERFORMED ON THE GIS DATA. IT WAS INSERTED INTO OUR DRAWING FILE AS PROVIDED. NO ACCURACY OR POSITIONAL TOLERANCE IS GUARANTEED BY THIS SURVEY AS TO HOW THE SURVEYED FEATURES TRULY RELATE TO THE GIS INFORMATION SHOWN HEREON.
- 5) ALL DISTANCES AND COORDINATES SHOWN HEREON ARE LOCALIZED, GROUND INFORMATION, UNLESS SPECIFICALLY NOTED AS "GRID".
- 6) LOCATION SHOWN DOES NOT MEET SPECIFIED ACCURACY AND SHOULD BE CONSIDERED FOR REFERENCE ONLY.

BOUNDARY ---X-X-WIRE FENCE ----- GRAVEL — ··· — EDGE OF WATER — — — — STORM DRAIN PIPE ------PAVEMENT ______ __ __ MINOR CONTOUR — — MAJOR CONTOUR ----- DIRT PATH (SEE NOTE 6) ----- FLOOD ZONE 1% FUTURE CONDITIONS BOLLARD ELECTRIC CONTROL BOX


- PROPERTY MONUMENT
- PLASTIC MANHOLE LID ♦ TV PEDESTAL
- W WATER METER
- ₩ATER VALVE
- CURB INLET
- SANITARY CLEAN OUT
- F ELECTRIC TRANSFORMER
- FIBER OPTIC VAULT
- ♥ UTILITY POLE → SIGN
- W DRILLED WELLS (SEE NOTE 6)


FIBER HANDHOLE

GAS TANK MAILBOX

I CERTIFY THAT THIS PROJECT WAS COMPLETED UNDER MY SUPERVISION FROM AN ACTUAL SURVEY MADE UNDER MY SUPERVISION; THAT THIS GROUND SURVEY WAS PERFORMED AT THE 95% CONFIDENCE LEVEL TO MEET FEDERAL GEOGRAPHIC DATA COMMITTEE STANDARDS; THAT THIS SURVEY WAS PERFORMED TO MEET THE REQUIREMENTS FOR A TOPOGRAPHIC/PLANIMETRIC SURVEY TO THE ACCURACY OF CLASS A STANDARD AND VERTICAL ACCURACY WHEN APPLICABLE TO THE CLASS A STANDARD, AND THAT THE ORIGINAL DATA WAS OBTAINED ON 5/21/21; THAT THE SURVEY WAS COMPLETED ON 5/24/21; THAT CONTOURS SHOWN MAY NOT MEET THE STATED STANDARD; AND ALL COORDINATES ARE BASED ON 'NAD 83' AND REALIZATION (2011) AND ALL ELEVATIONS ARE BASED ON NAVD 88 GEOID 12B.



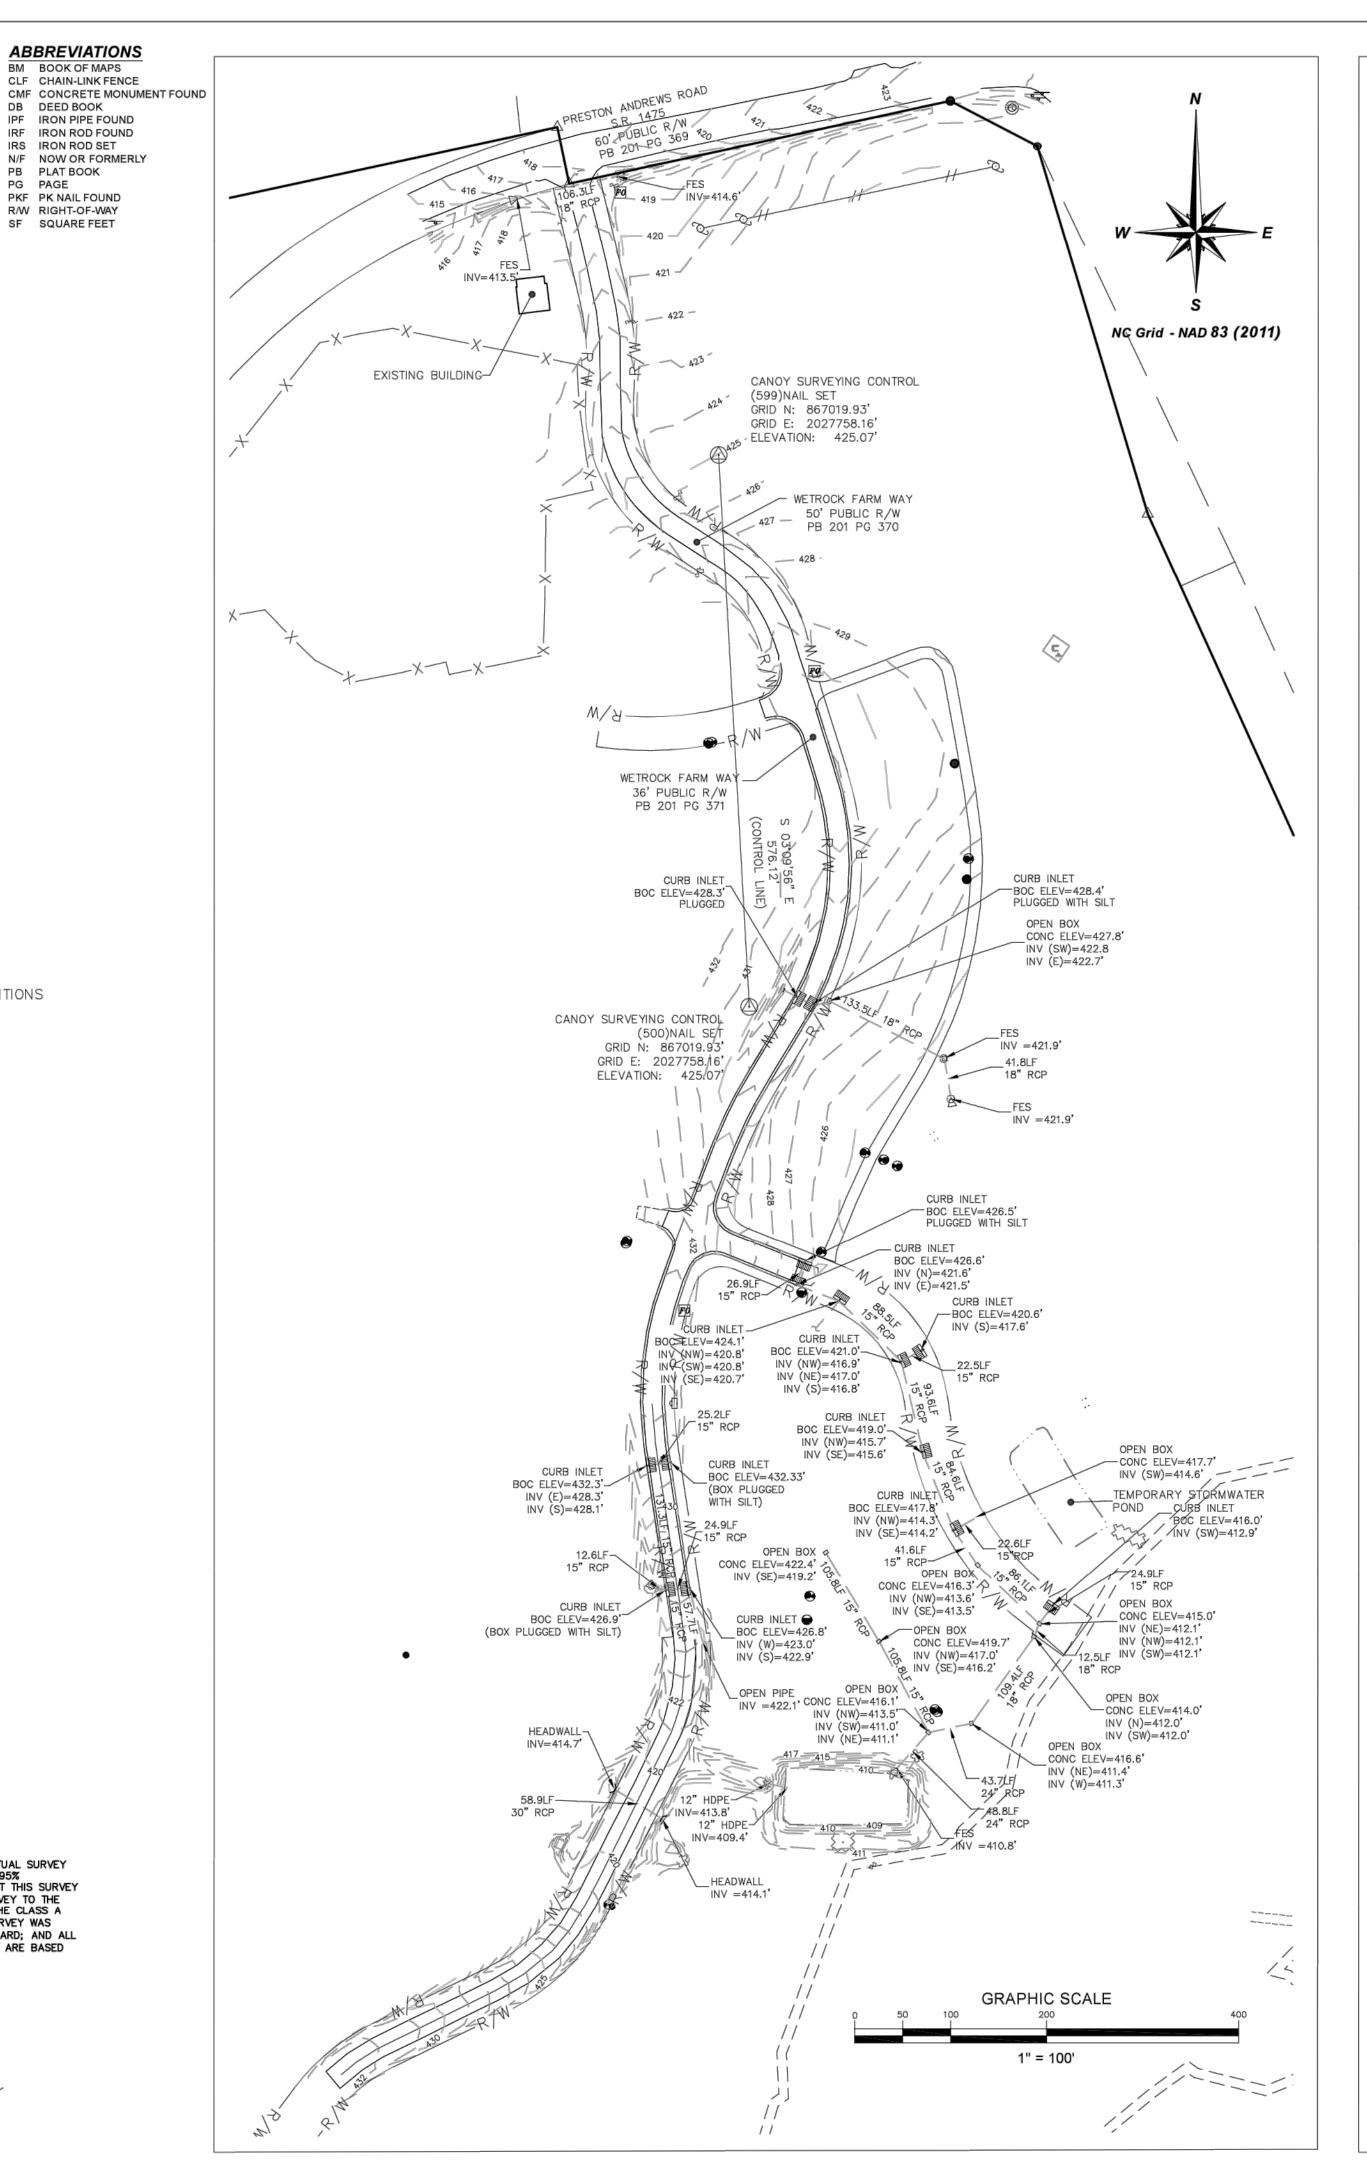

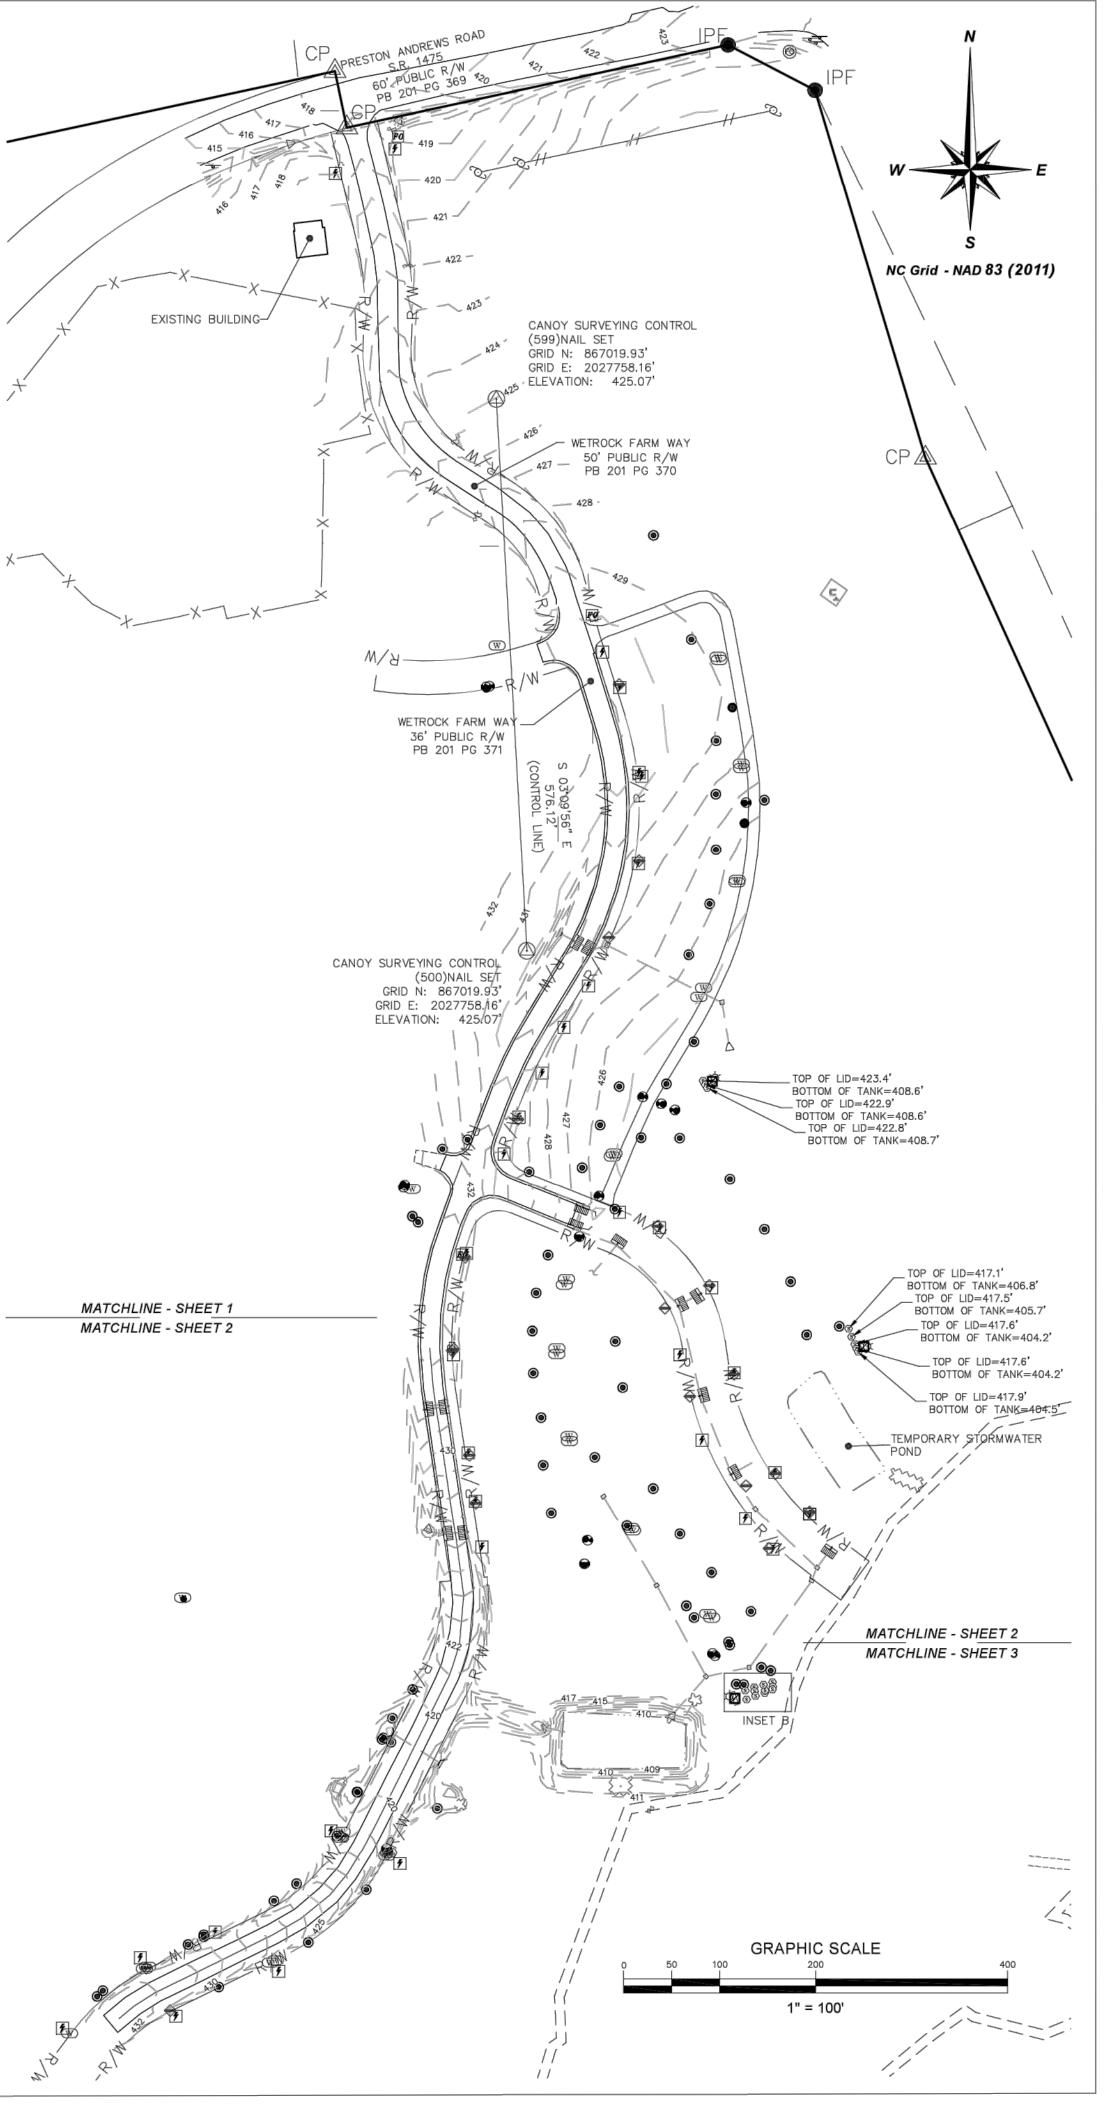

NE 1 262 CANOY


EXISTING UTILITIES SUBDIVISION SURVEY /

OGRAPHIC S STON ANDI COUNTY -

REVISIONS:

DATE OF 5/27/2021 SURVEY: SCALE: 1" = 100'

DRAWN BY: ARC CHECKED BY: ADAM R. CANOY, PLS PROJECT: WETROCK ASB

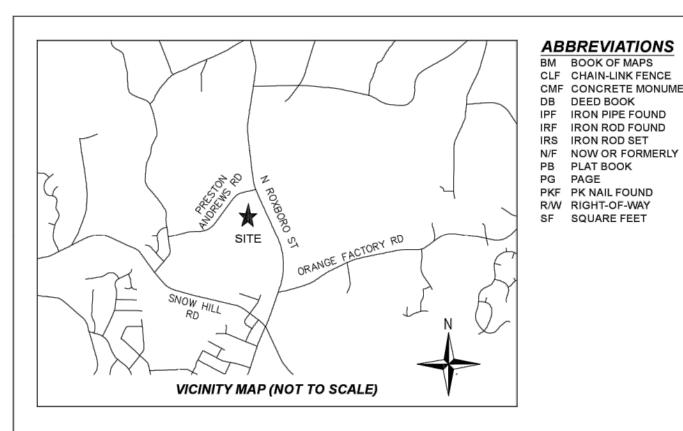

GENERAL NOTES1) THE PURPOSE OF THIS PLAT IS A TOPOGRAPHIC SURVEY OF THE SITE SHOWN AS REQUESTED BY MACCONNELL AND ASSOCIATES, AND

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LEGEND

XX	BOUNDARY WIRE FENCE GRAVEL EDGE OF WATER STORM DRAIN PIPE PAVEMENT MINOR CONTOUR MAJOR CONTOUR OVERHEAD ELECTRIC LINE RIPRAP DIRT PATH (SEE NOTE 6) FLOOD ZONE 1% FUTURE CONDITIONS FLOOD ZONE AE TOP OF BANK BOLLARD
	ELECTRIC CONTROL BOX
0	ELEC METER

 PLASTIC MANHOLE LID ♦ TV PEDESTAL

PROPERTY MONUMENT

W WATER METER

☆ LIT POLE


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- **W** UTILITY POLE → SIGN W DRILLED WELLS (SEE NOTE 6)
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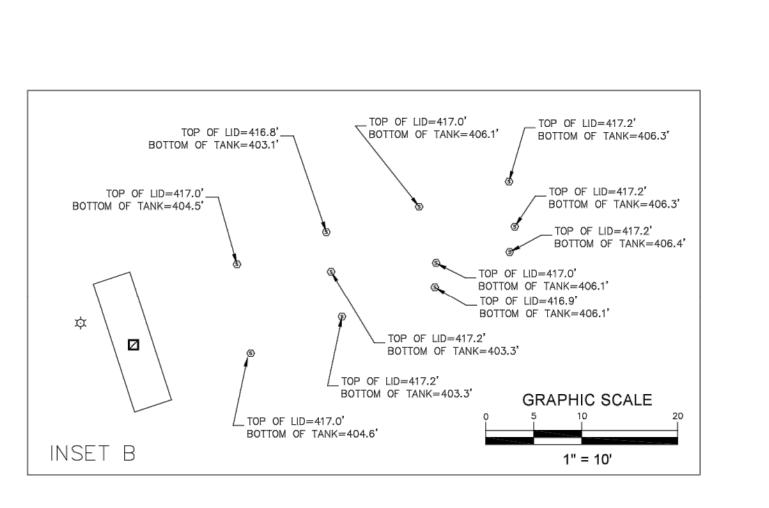
MAILBOX


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THIS 27th DAY OF May, 2021. SEAL ADAM R. CANOY, PLS L-5276







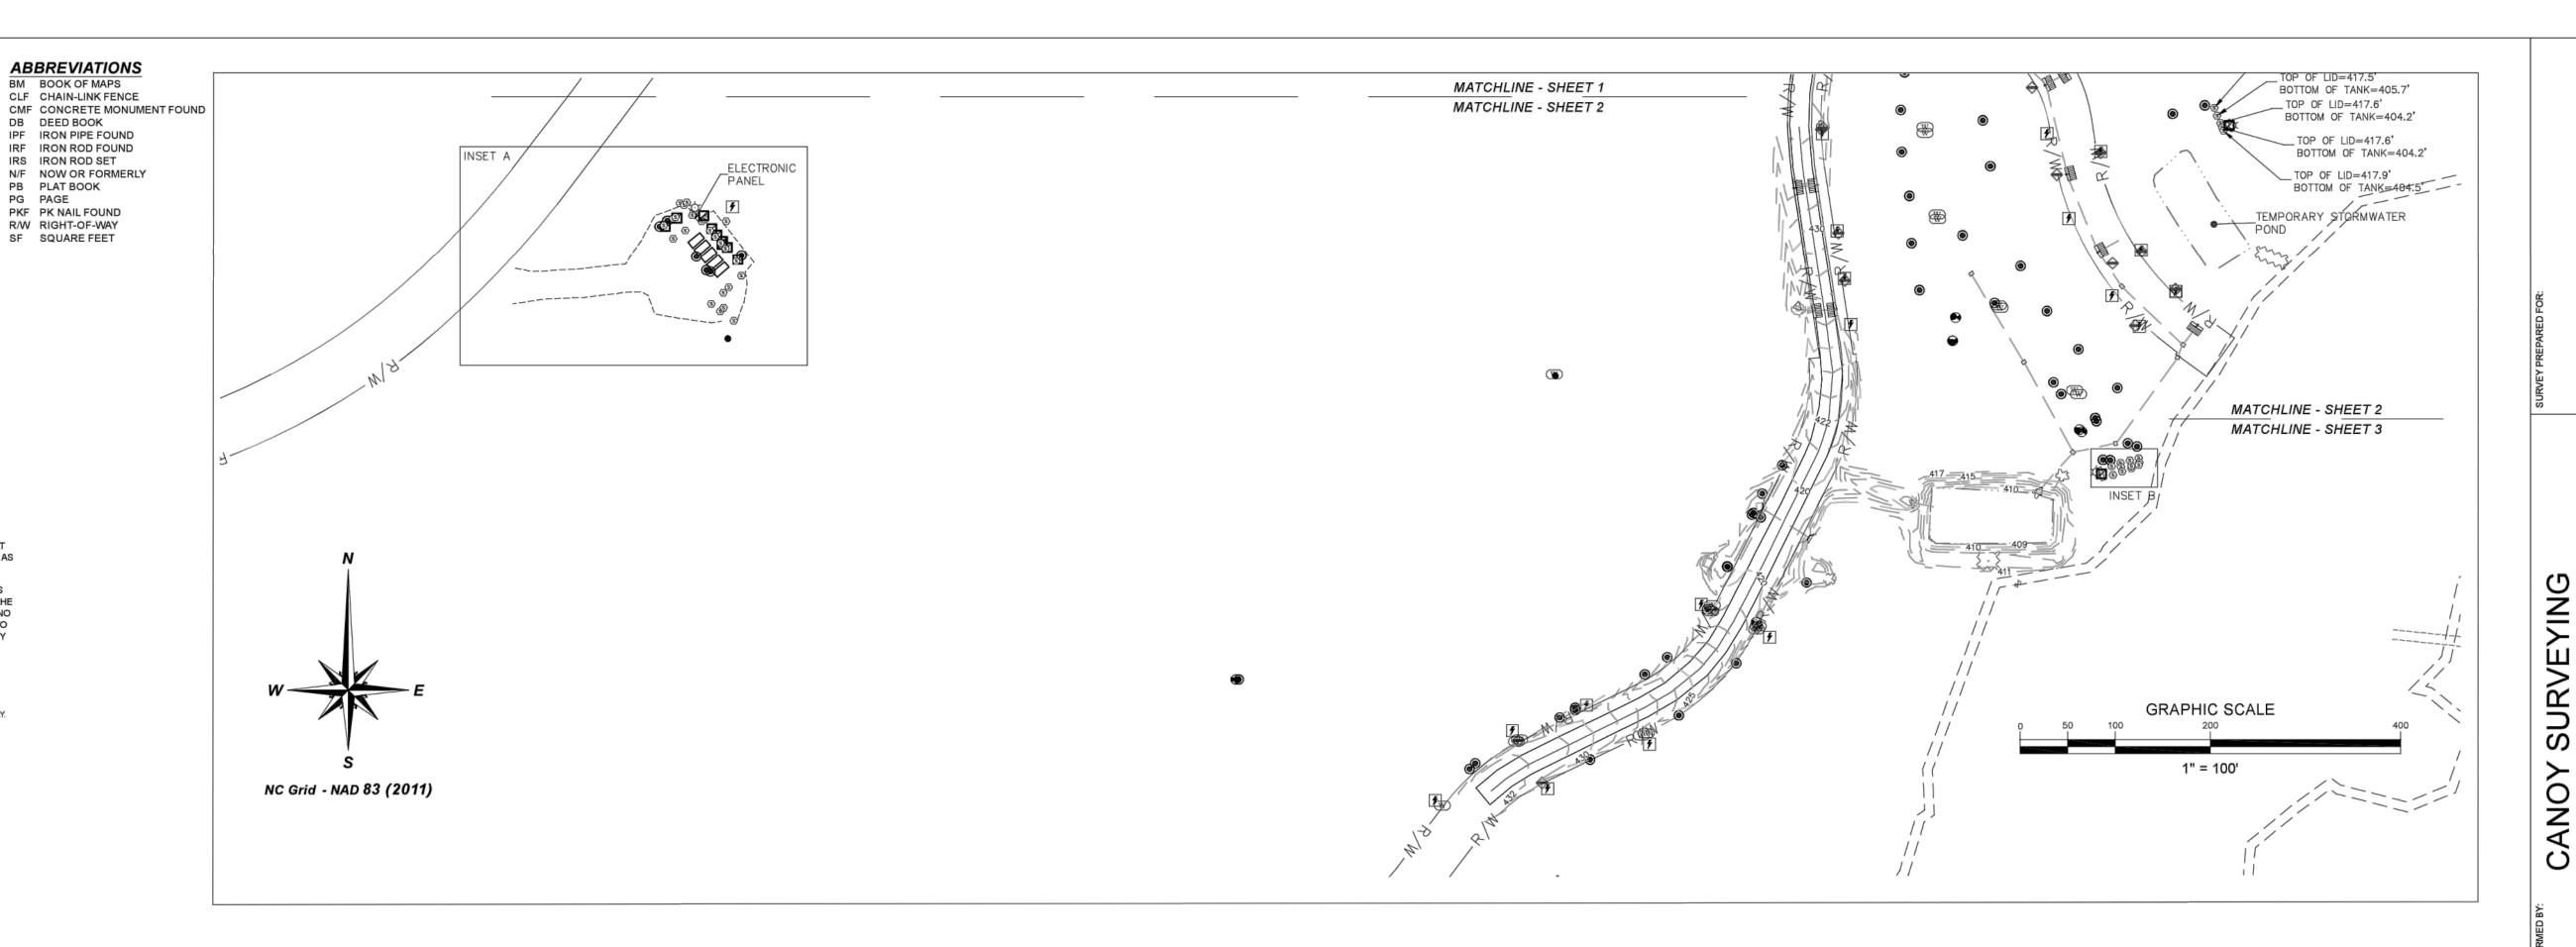

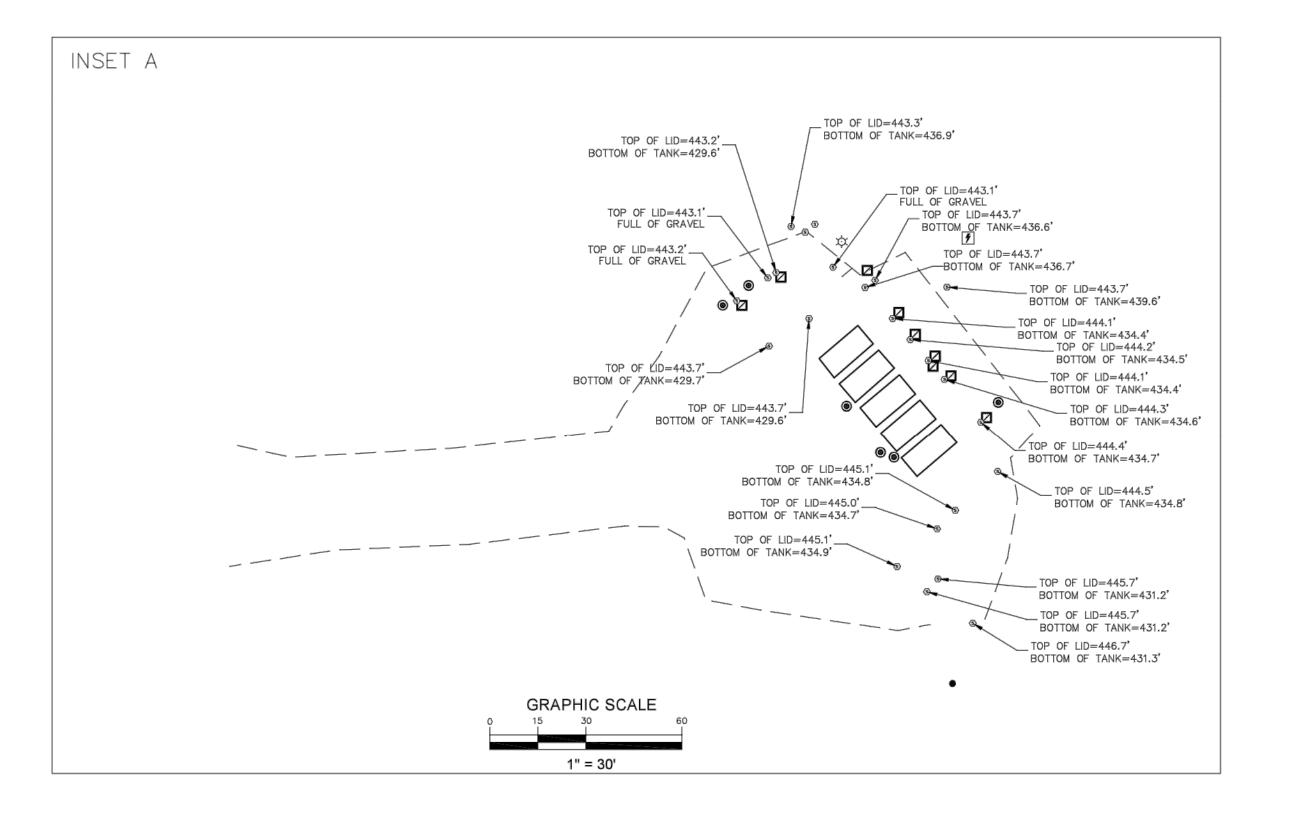LANE 7581 7-262(


1154 SHONE (98

SURVEY SUBDIVISION FARM S CK

COU

REVISIONS:

5/27/2021 SURVEY: SCALE: 1" = 100' DRAWN BY: ARC CHECKED BY: ADAM R. CANOY, PLS PROJECT: WETROCK ASB

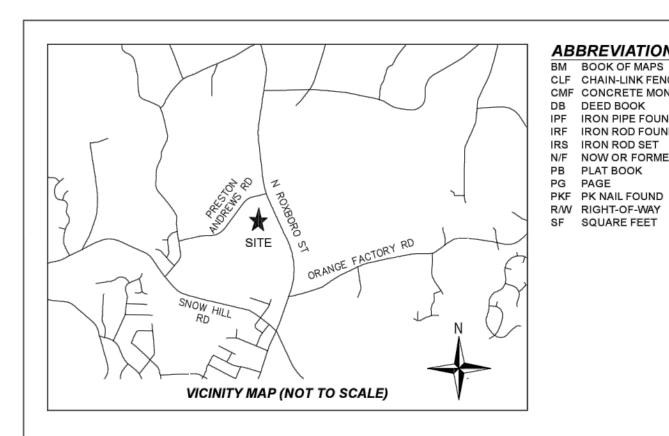

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LEGEND


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•	BOLLARD
	ELECTRIC CONTROL BOX

- ELEC METER PROPERTY MONUMENT
- → TV PEDESTAL
- W WATER METER
- ₩ATER VALVE ■ CURB INLET
- SANITARY CLEAN OUT
- F ELECTRIC TRANSFORMER
- M FIBER HANDHOLE
- FIBER OPTIC VAULT
- 🗞 UTILITY POLE → SIGN
- W DRILLED WELLS (SEE NOTE 6) GAS TANK
- MAILBOX

I CERTIFY THAT THIS PROJECT WAS COMPLETED UNDER MY SUPERVISION FROM AN ACTUAL SURVEY MADE UNDER MY SUPERVISION; THAT THIS GROUND SURVEY WAS PERFORMED AT THE 95% CONFIDENCE LEVEL TO MEET FEDERAL GEOGRAPHIC DATA COMMITTEE STANDARDS; THAT THIS SURVEY WAS PERFORMED TO MEET THE REQUIREMENTS FOR A TOPOGRAPHIC/PLANIMETRIC SURVEY TO THE ACCURACY OF CLASS A STANDARD AND VERTICAL ACCURACY WHEN APPLICABLE TO THE CLASS A STANDARD, AND THAT THE ORIGINAL DATA WAS OBTAINED ON 5/21/21; THAT THE SURVEY WAS COMPLETED ON 5/24/21; THAT CONTOURS SHOWN MAY NOT MEET THE STATED STANDARD; AND ALL COORDINATES ARE BASED ON 'NAD 83' AND REALIZATION (2011) AND ALL ELEVATIONS ARE BASED ON NAVD 88 GEOID 12B.


ADAM R. CANOY, PLS L-5276



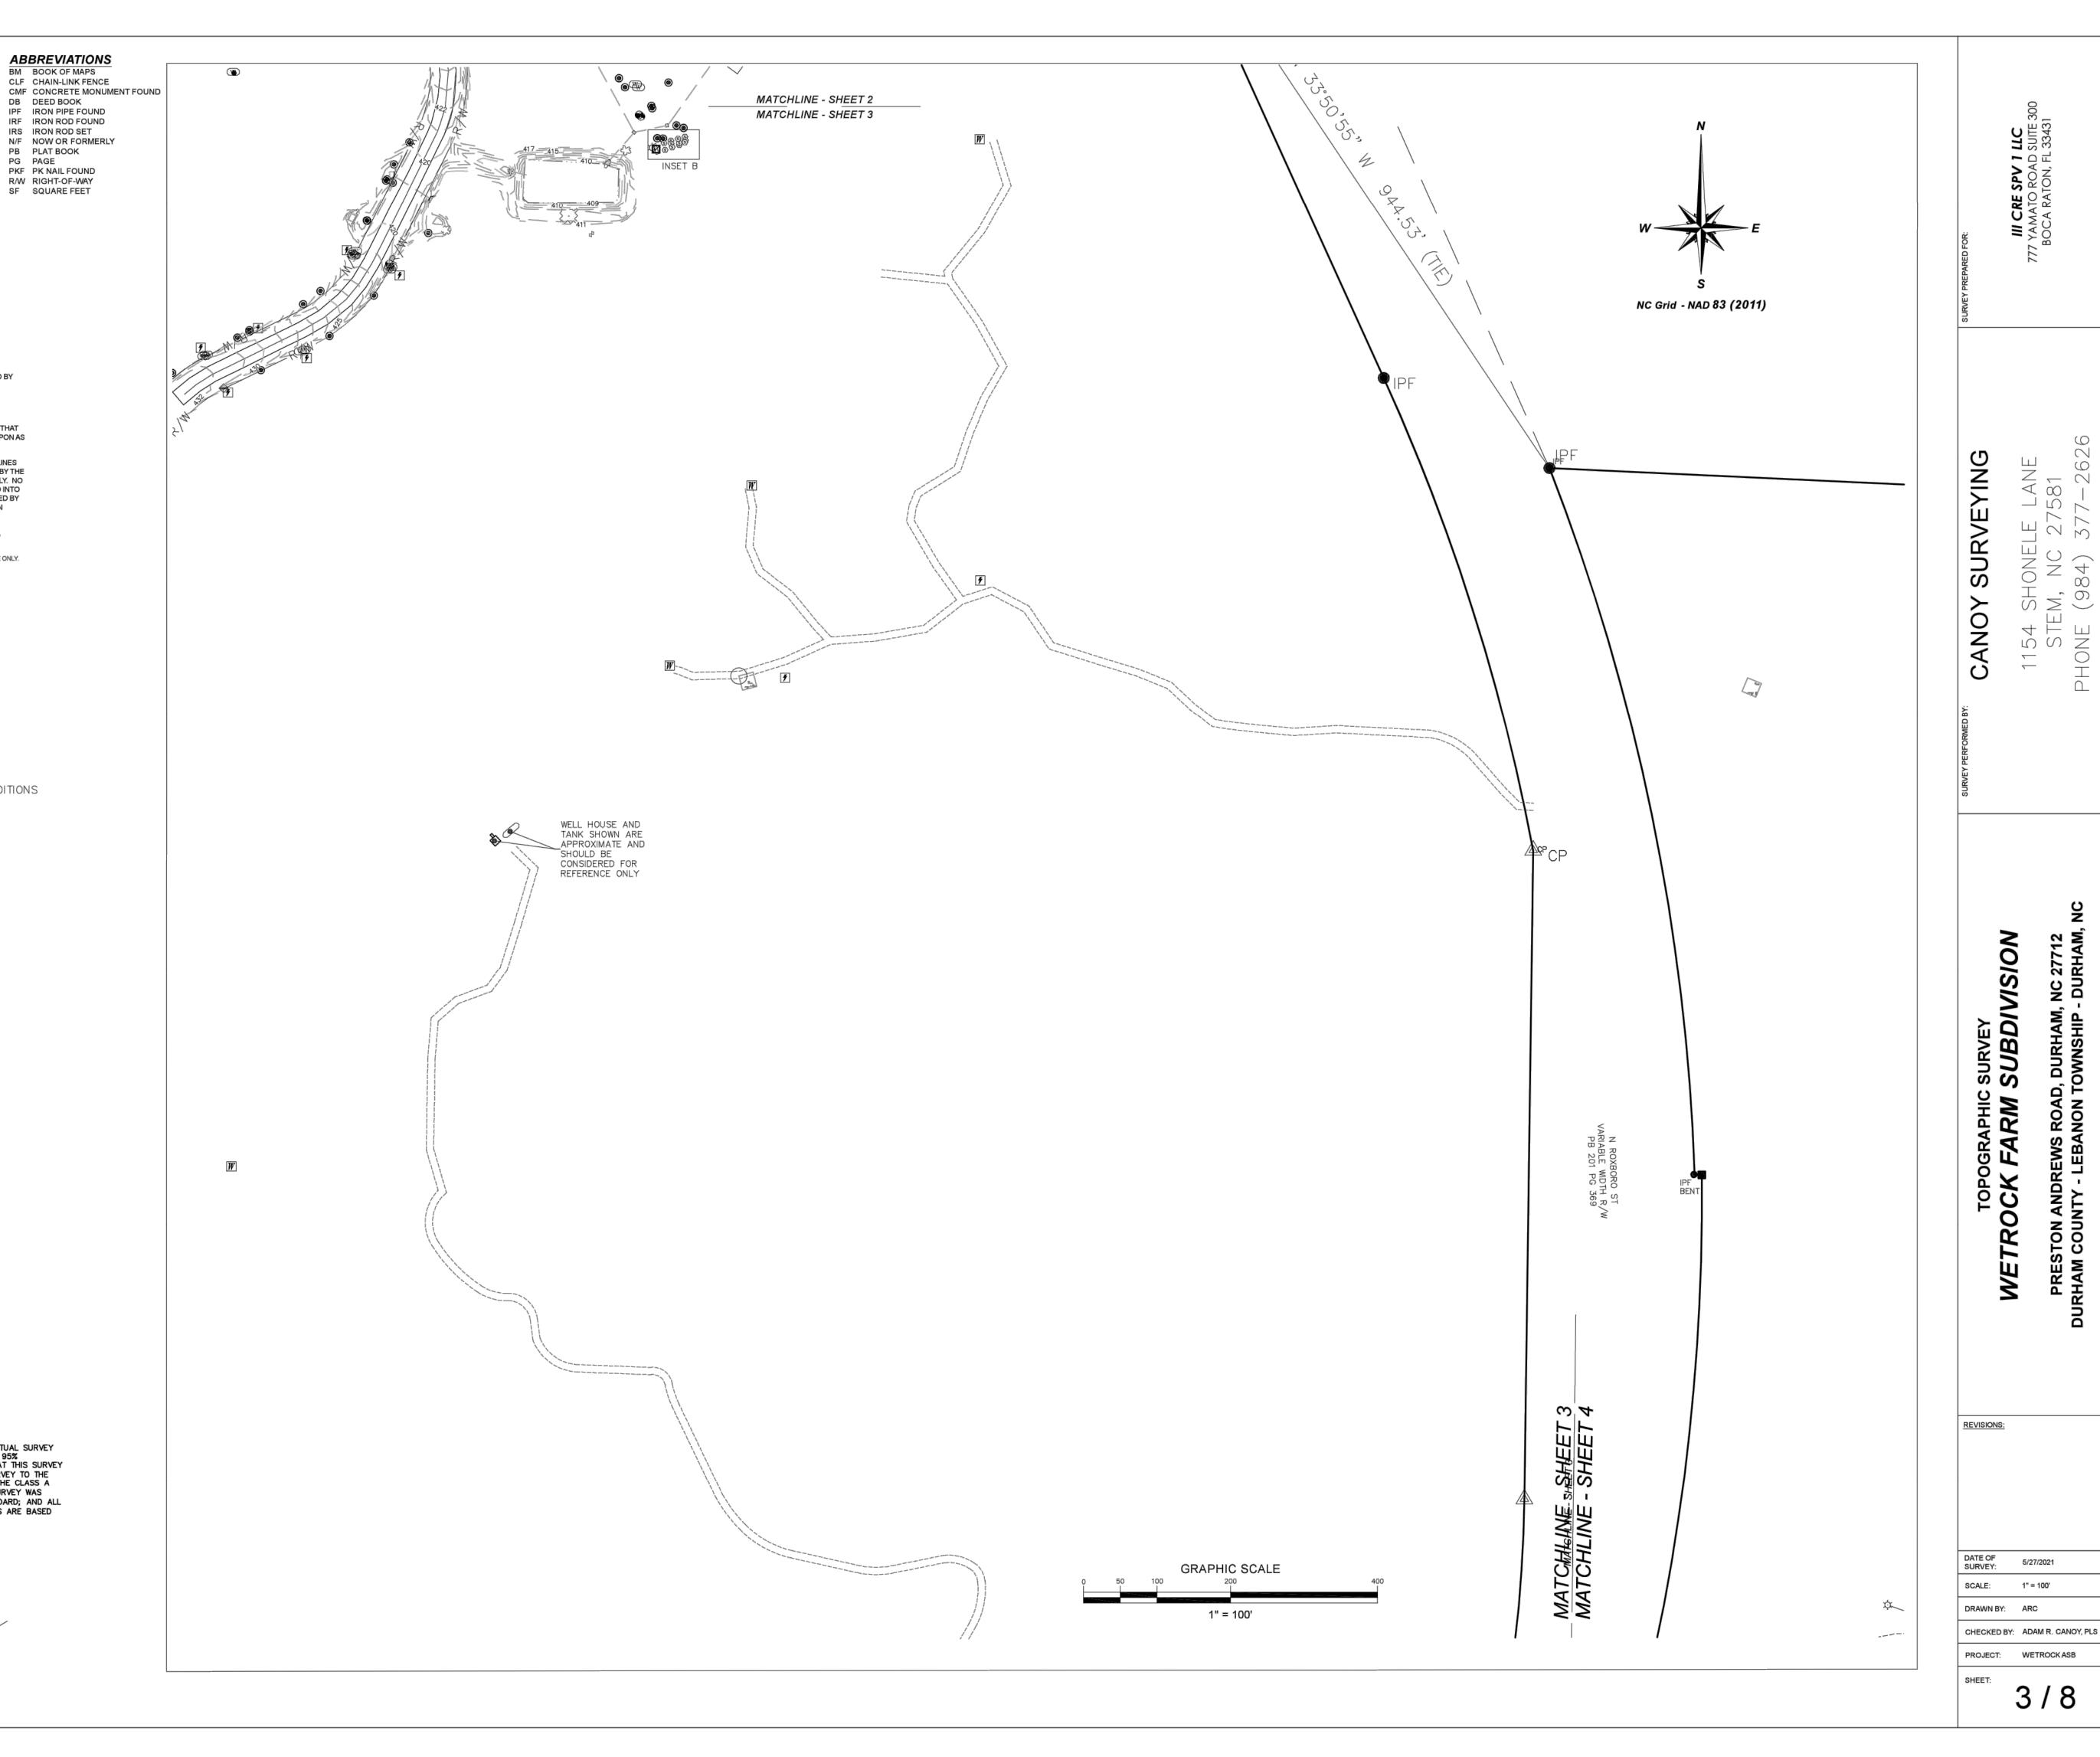

5/27/2021

WETROCK ASB

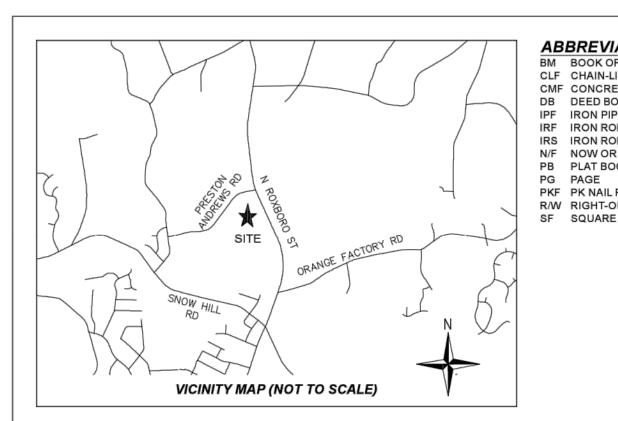

GENERAL NOTES

1) THE PURPOSE OF THIS PLAT IS A TOPOGRAPHIC SURVEY OF THE SITE SHOWN AS REQUESTED BY MACCONNELL AND ASSOCIATES, AND

LOT LINES SHOWN ARE SOLEY BASED ON DURHAM GIS AND HAVE NOT BEEN SURVEYED OR CONFIRMED. THEY ARE SHOWN FOR REFERENCE ONLY.

3) PROPERTIES SHOWN HEREON ARE SUBJECT TO EASEMENTS AND RESTRICTIONS OF RECORD THAT WOULD BE REVEALED BY A THOROUGH TITLE SEARCH. THIS PLAT SHOULD NOT BE RELIED UPON AS A COMPLETE RECORD OF ALL EASEMENTS THAT MAY EFFECT THESE PROPERTIES.

4) THIS MAP DOES NOT REPRESENT A BOUNDARY SURVEY, PROPERTY LINES, STREAM CENTERLINES AND PLANIMETRIC INFORMATION SHOWN HEREON WERE TAKEN FROM CAD FILES PROVIDED BY THE CLIENT; AND THIS INFORMATION HAS BEEN SHOWN HEREON FOR REFERENCE PURPOSES ONLY. NO TRANSLATION, ROTATION OR SCALING WAS PERFORMED ON THE GIS DATA. IT WAS INSERTED INTO OUR DRAWING FILE AS PROVIDED. NO ACCURACY OR POSITIONAL TOLERANCE IS GUARANTEED BY THIS SURVEY AS TO HOW THE SURVEYED FEATURES TRULY RELATE TO THE GIS INFORMATION SHOWN HEREON.

5) ALL DISTANCES AND COORDINATES SHOWN HEREON ARE LOCALIZED, GROUND INFORMATION, UNLESS SPECIFICALLY NOTED AS "GRID".

6) LOCATION SHOWN DOES NOT MEET SPECIFIED ACCURACY AND SHOULD BE CONSIDERED FOR REFERENCE ONLY.

LEGEND

_	
	BOUNDARY
××	WIRE FENCE
	GRAVEL
	EDGE OF WATER
	STORM DRAIN PIPE
	PAVEMENT
	MINOR CONTOUR
	MAJOR CONTOUR
	OVERHEAD ELECTRIC LINE
	RIPRAP
	DIRT PATH (SEE NOTE 6)
	FLOOD ZONE 1% FUTURE CONDITION
	FLOOD ZONE AE
	TOP OF BANK
•	BOLLARD

- ELECTRIC CONTROL BOX
- ELEC METER PROPERTY MONUMENT
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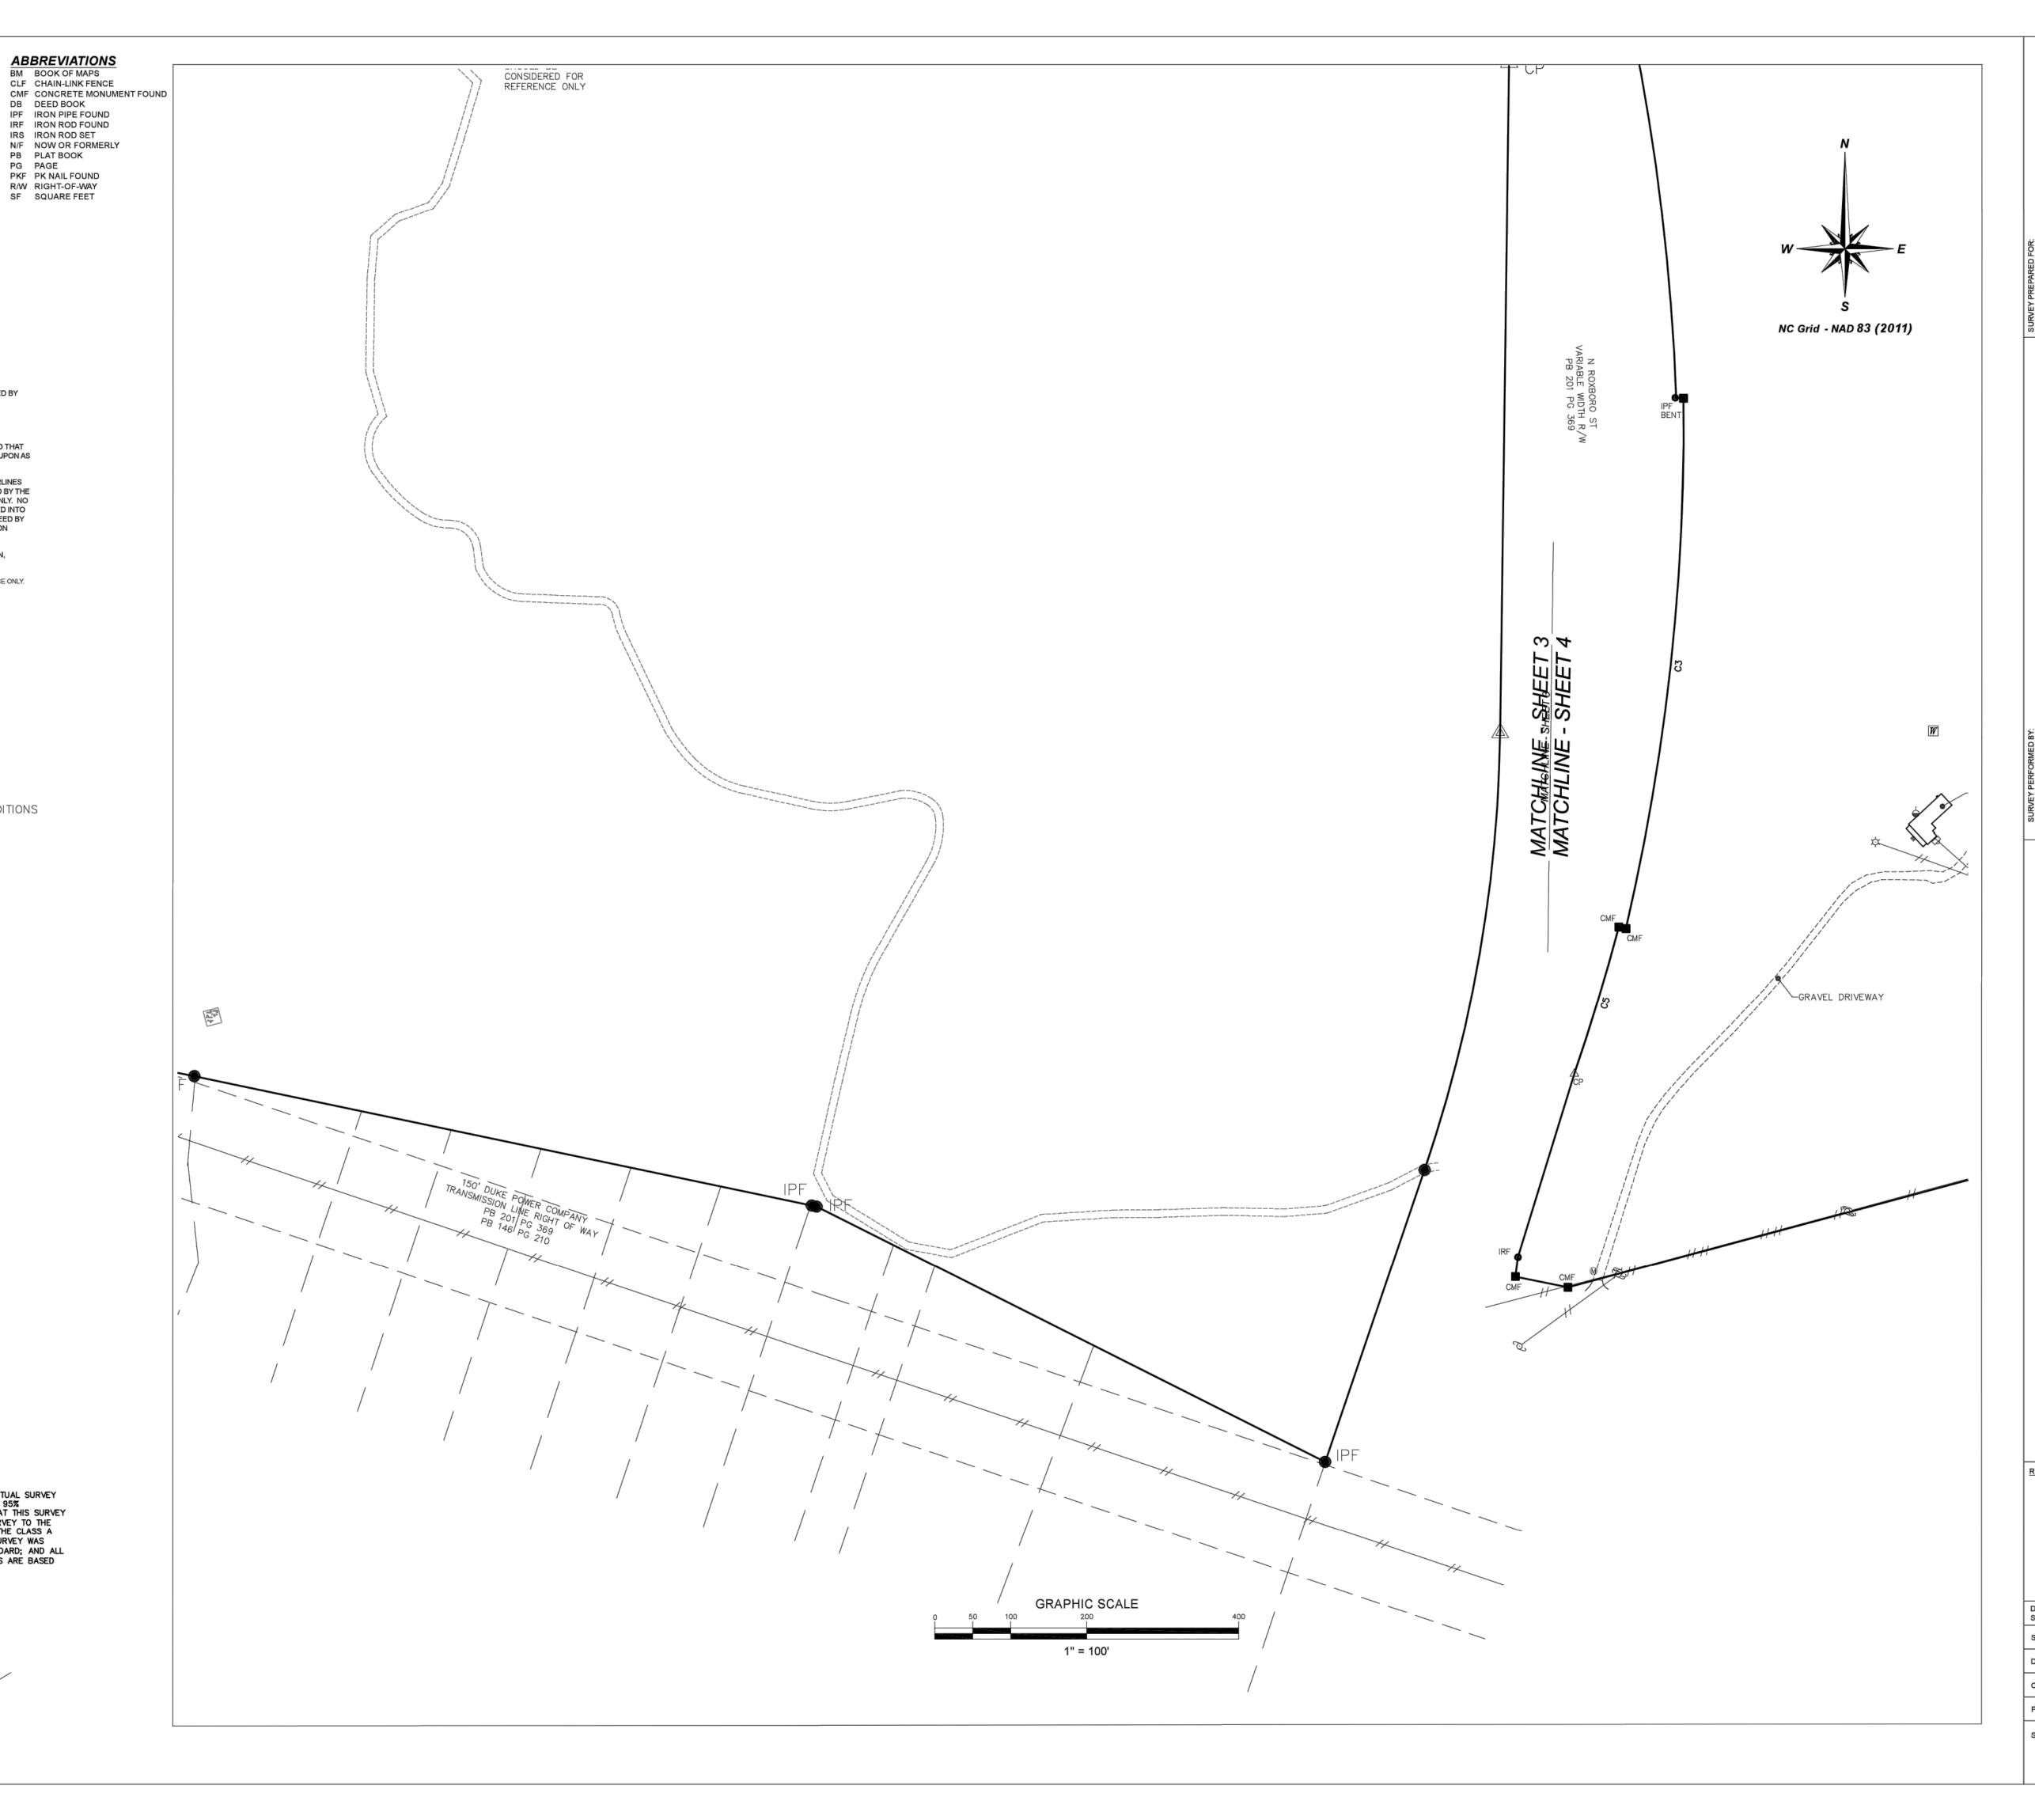
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- © PLASTIC MANHOLE LID
- → TV PEDESTAL
- W WATER METER
- → WATER VALVE
- SANITARY CLEAN OUT
- F ELECTRIC TRANSFORMER
- F FIBER HANDHOLE
- FIBER OPTIC VAULT ♥ UTILITY POLE
- → SIGN
- M DRILLED WELLS (SEE NOTE 6)
- GAS TANK M MAILBOX

I CERTIFY THAT THIS PROJECT WAS COMPLETED UNDER MY SUPERVISION FROM AN ACTUAL SURVEY MADE UNDER MY SUPERVISION; THAT THIS GROUND SURVEY WAS PERFORMED AT THE 95% CONFIDENCE LEVEL TO MEET FEDERAL GEOGRAPHIC DATA COMMITTEE STANDARDS; THAT THIS SURVEY WAS PERFORMED TO MEET THE REQUIREMENTS FOR A TOPOGRAPHIC/PLANIMETRIC SURVEY TO THE ACCURACY OF CLASS A STANDARD AND VERTICAL ACCURACY WHEN APPLICABLE TO THE CLASS A STANDARD, AND THAT THE ORIGINAL DATA WAS OBTAINED ON 5/21/21; THAT THE SURVEY WAS COMPLETED ON 5/24/21; THAT CONTOURS SHOWN MAY NOT MEET THE STATED STANDARD; AND ALL COORDINATES ARE BASED ON 'NAD 83' AND REALIZATION (2011) AND ALL ELEVATIONS ARE BASED

ADAM R. CANOY, PLS L-5276





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CANOY


S SURVEY SUBDIVISION TOPOGRAPHIC S

TRO

REVISIONS:

5/27/2021 SURVEY: SCALE: 1" = 100'

DRAWN BY: ARC CHECKED BY: ADAM R. CANOY, PLS PROJECT: WETROCK ASB

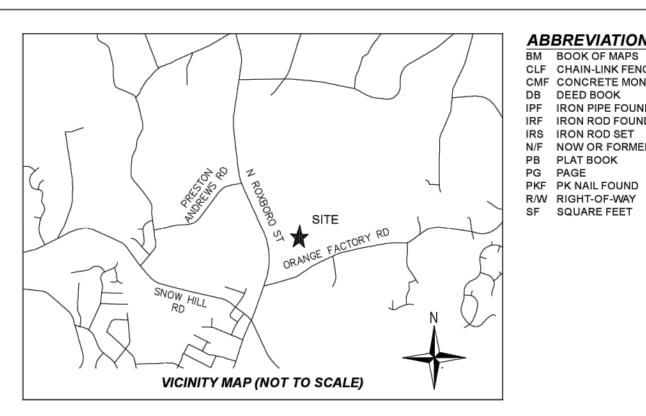

ABBREVIATIONS BM BOOK OF MAPS CLF CHAIN-LINK FENCE

DB DEED BOOK IPF IRON PIPE FOUND IRF IRON ROD FOUND IRS IRON ROD SET N/F NOW OR FORMERLY PB PLAT BOOK

R/W RIGHT-OF-WAY SF SQUARE FEET

GENERAL NOTES 1) THE PURPOSE OF THIS PLAT IS AN AS-BUILT SURVEY OF THE EXISTING HOUSE AND DRIVEWAY.

LOT LINES SHOWN ARE SOLEY BASED ON DURHAM GIS AND HAVE NOT BEEN SURVEYED OR CONFIRMED. THEY ARE SHOWN FOR REFERENCE ONLY.

3) PROPERTIES SHOWN HEREON ARE SUBJECT TO EASEMENTS AND RESTRICTIONS OF RECORD THAT WOULD BE REVEALED BY A THOROUGH TITLE SEARCH. THIS PLAT SHOULD NOT BE RELIED UPON AS A COMPLETE RECORD OF ALL EASEMENTS THAT MAY EFFECT THESE PROPERTIES.

4) THIS MAP DOES NOT REPRESENT A BOUNDARY SURVEY. PROPERTY LINES, STREAM CENTERLINES AND PLANIMETRIC INFORMATION SHOWN HEREON WERE TAKEN FROM CAD FILES PROVIDED BY THE CLIENT; AND THIS INFORMATION HAS BEEN SHOWN HEREON FOR REFERENCE PURPOSES ONLY. NO TRANSLATION, ROTATION OR SCALING WAS PERFORMED ON THE GIS DATA. IT WAS INSERTED INTO OUR DRAWING FILE AS PROVIDED. NO ACCURACY OR POSITIONAL TOLERANCE IS GUARANTEED BY THIS SURVEY AS TO HOW THE SURVEYED FEATURES TRULY RELATE TO THE GIS INFORMATION

5) ALL DISTANCES AND COORDINATES SHOWN HEREON ARE LOCALIZED, GROUND INFORMATION,

6) LOCATION SHOWN DOES NOT MEET SPECIFIED ACCURACY AND SHOULD BE CONSIDERED FOR

7) AERIAL IMAGERY SHOWN FOR REFERENCE ONLY. IT WAS DOWLOADED FROM NO ONE MAP ON

IFGEND

	LGLIND
//	BOUNDARY WIRE FENCE GRAVEL EDGE OF WATER STORM DRAIN PIPE PAVEMENT MINOR CONTOUR MAJOR CONTOUR OVERHEAD ELECTRIC LINE RIPRAP DIRT PATH (SEE NOTE 6) FLOOD ZONE 1% FUTURE CONDITIONS FLOOD ZONE AE TOP OF BANK BOLLARD
	ELECTRIC CONTROL BOX
₫	ELEC METER
•	PROPERTY MONUMENT
\$	LIT POLE
S	PLASTIC MANHOLE LID

♦ TV PEDESTAL W WATER METER → WATER VALVE

□□ CURB INLET

SANITARY CLEAN OUT F ELECTRIC TRANSFORMER

M FIBER HANDHOLE

FIBER OPTIC VAULT **Q** UTILITY POLE


→ SIGN M DRILLED WELLS (SEE NOTE 6)

GAS TANK MAILBOX

I CERTIFY THAT THIS PROJECT WAS COMPLETED UNDER MY SUPERVISION FROM AN ACTUAL SURVEY MADE UNDER MY SUPERVISION; THAT THIS GROUND SURVEY WAS PERFORMED AT THE 95% CONFIDENCE LEVEL TO MEET FEDERAL GEOGRAPHIC DATA COMMITTEE STANDARDS; THAT THIS SURVEY WAS PERFORMED TO MEET THE REQUIREMENTS FOR A TOPOGRAPHIC/PLANIMETRIC SURVEY TO THE ACCURACY OF CLASS A STANDARD AND VERTICAL ACCURACY WHEN APPLICABLE TO THE CLASS A STANDARD, AND THAT THE ORIGINAL DATA WAS OBTAINED ON 5/21/21; THAT THE SURVEY WAS COMPLETED ON 5/24/21; THAT CONTOURS SHOWN MAY NOT MEET THE STATED STANDARD; AND ALL COORDINATES ARE BASED ON 'NAD 83' AND REALIZATION (2011) AND ALL ELEVATIONS ARE BASED ON NAVD 88 GEOID 12B.

ADAM R. CANOY, PLS L-5276



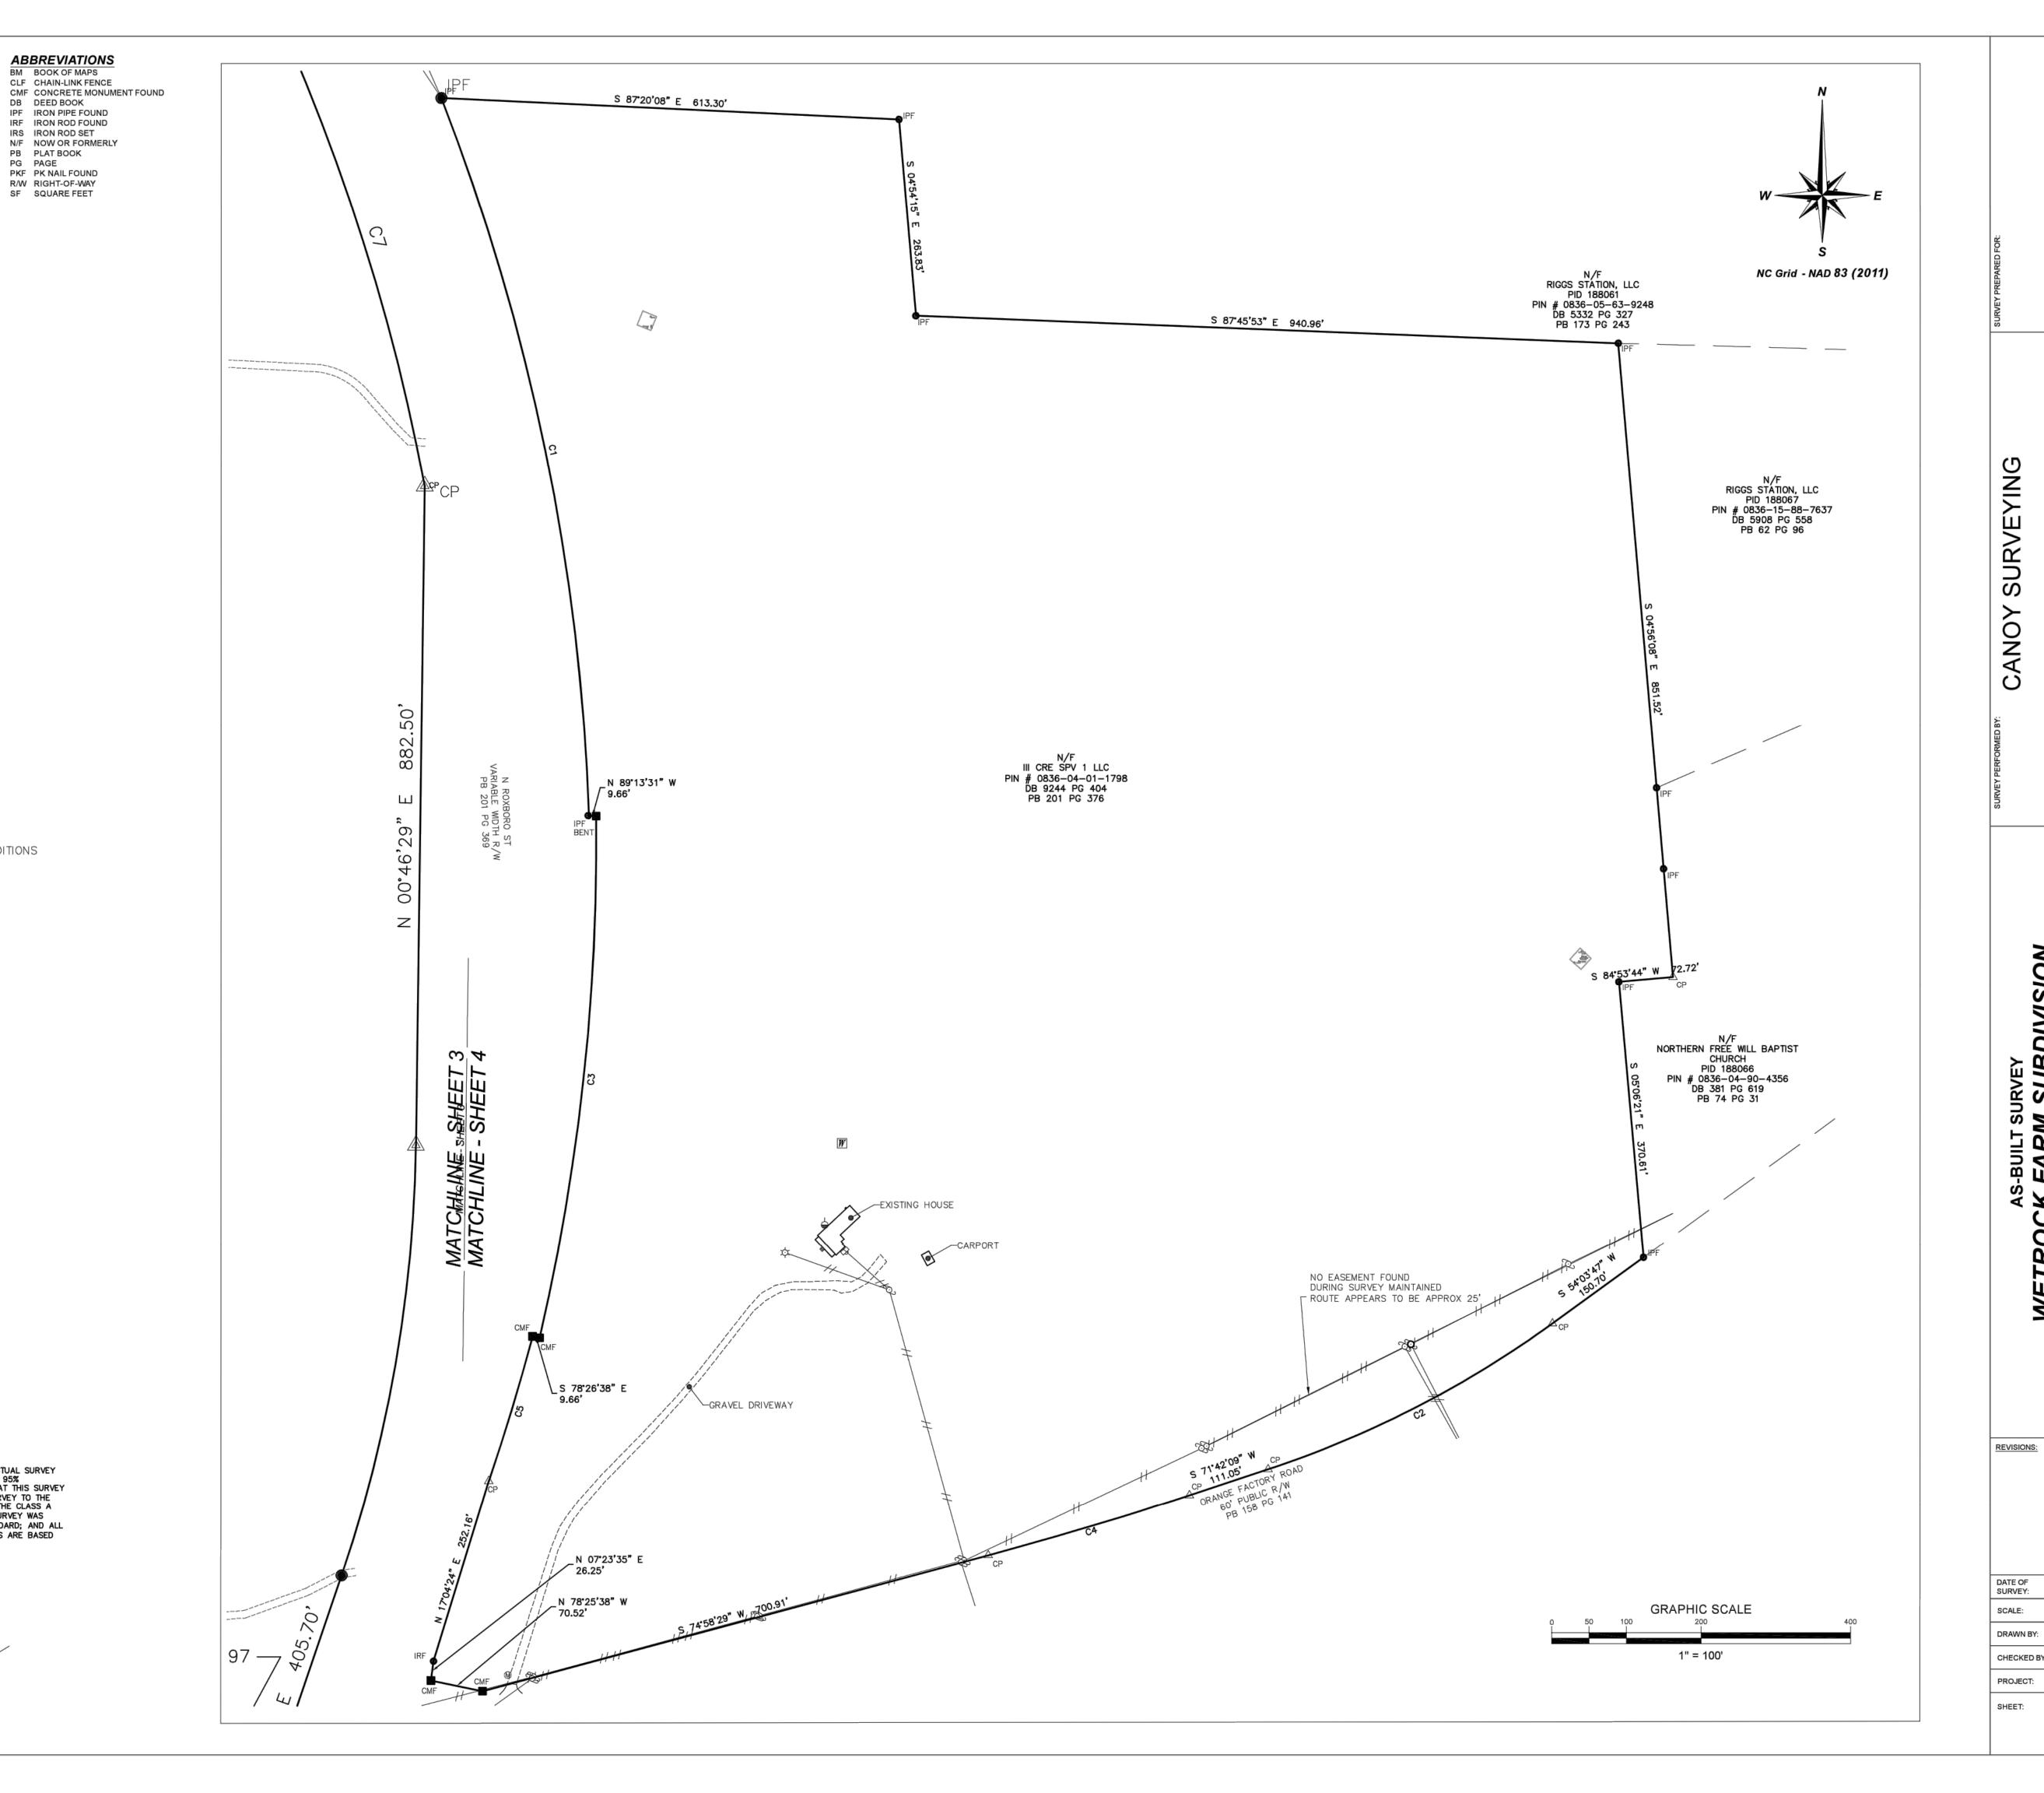

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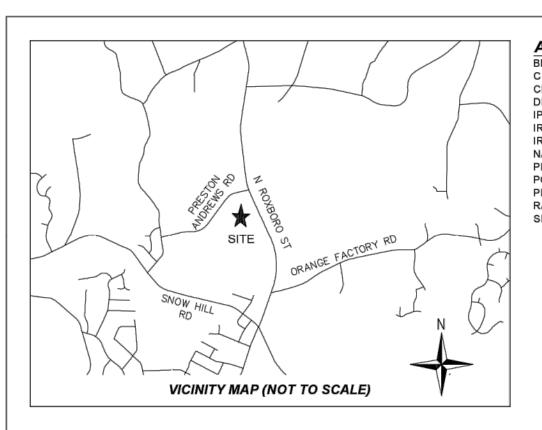
1154 SHON STEM, N PHONE (984

DIVISION S-BUILT SURVEY
FARM SUBI

5/27/2021 SURVEY: SCALE: 1" = 100' DRAWN BY: ARC CHECKED BY: ADAM R. CANOY, PLS

5/8

WETROCK ASB



GENERAL NOTES 1) THE PURPOSE OF THIS PLAT IS A BOUNDARY SURVEY OF THE PROPERTY LINES SHOWN.

- CANOY SURVEYINGS TASK WAS SURVEY THE BOUNDARY OF THE LARGE SUBJECT PARCEL. INTERNAL LOT LINES, ROAD RIGHT OF WAYS, AND EXISTING EASEMENTS EXIST FROM PREVIOUS SUBDIVISION AS SHOWN IN PB 201 PG 367-379 BUT ARE SUBJECT TO CHANGE.
- 3) PROPERTIES SHOWN HEREON ARE SUBJECT TO EASEMENTS AND RESTRICTIONS OF RECORD THAT WOULD BE REVEALED BY A THOROUGH TITLE SEARCH. THIS PLAT SHOULD NOT BE RELIED UPON AS A COMPLETE RECORD OF ALL EASEMENTS THAT MAY EFFECT THESE PROPERTIES.
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- 5) ALL DISTANCES AND COORDINATES SHOWN HEREON ARE LOCALIZED, GROUND INFORMATION, UNLESS SPECIFICALLY NOTED AS "GRID".
- 6) STREAM BUFFERS AND STREAM TOB OF BANKS SHOWN ARE BASED ON INFORMATION PROVIDED BY THE CLIENT AND SHOWN ON PB 201 PG 367-379, AND HAVE NOT BEEN FIELD SURVEYED BY CANOY SURVEYING
- 7) FLOOD NOTE: A PORTION OF THIS PROPERTY IS LOCATED IN A SPECIAL FLOOD HAZARD ZONE. IT IS LOCATED IN ZONE "X", AND "AE" AS DEFINED BY F.E.M.A F.I.R.M COMMUNITY MAP #3720082600K

LEGEND


	BOUNDARY WIRE FENCE
	GRAVEL
	EDGE OF WATER
	STORM DRAIN PIPE
	PAVEMENT
	MINOR CONTOUR
	MAJOR CONTOUR
	OVERHEAD ELECTRIC LINE
	RIPRAP
	DIRT PATH (SEE NOTE 6)
	FLOOD ZONE 1% FUTURE CONDITION
	FLOOD ZONE AE
	TOP OF BANK
•	BOLLARD


- ☑ ELECTRIC CONTROL BOX
- PROPERTY MONUMENT
- → TV PEDESTAL
- W WATER METER
- ↔ WATER VALVE
- F ELECTRIC TRANSFORMER
- □ FLARED END SECTION


 □ FIBER HANDHOLE
- 6 FIBER OPTIC VAULT

I CERTIFY THAT THIS MAP WAS DRAWN UNDER MY SUPERVISION FROM AN ACTUAL SURVEY MADE UNDER MY SUPERVISION (DEED DESCRIPTION RECORDED IN DEED BOOK 9244, PAGE 404; THAT THE BOUNDARIES NOT SURVEYED ARE INDICATED AS DRAWN FROM INFORMATION DOWNLOADED FROM DURHAM COUNTY GIS AT THE TIME OF SURVEY; THAT THE RATIO OF PRECISION IS 1:29847+; AND THAT THIS MAP MEETS THE REQUIREMENTS OF THE STANDARDS OF PRACTICE FOR LAND SURVEYING IN NORTH CAROLINA (21 NCAC 56.1600).

SEAL WILLIAM SEAL

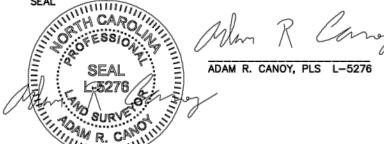

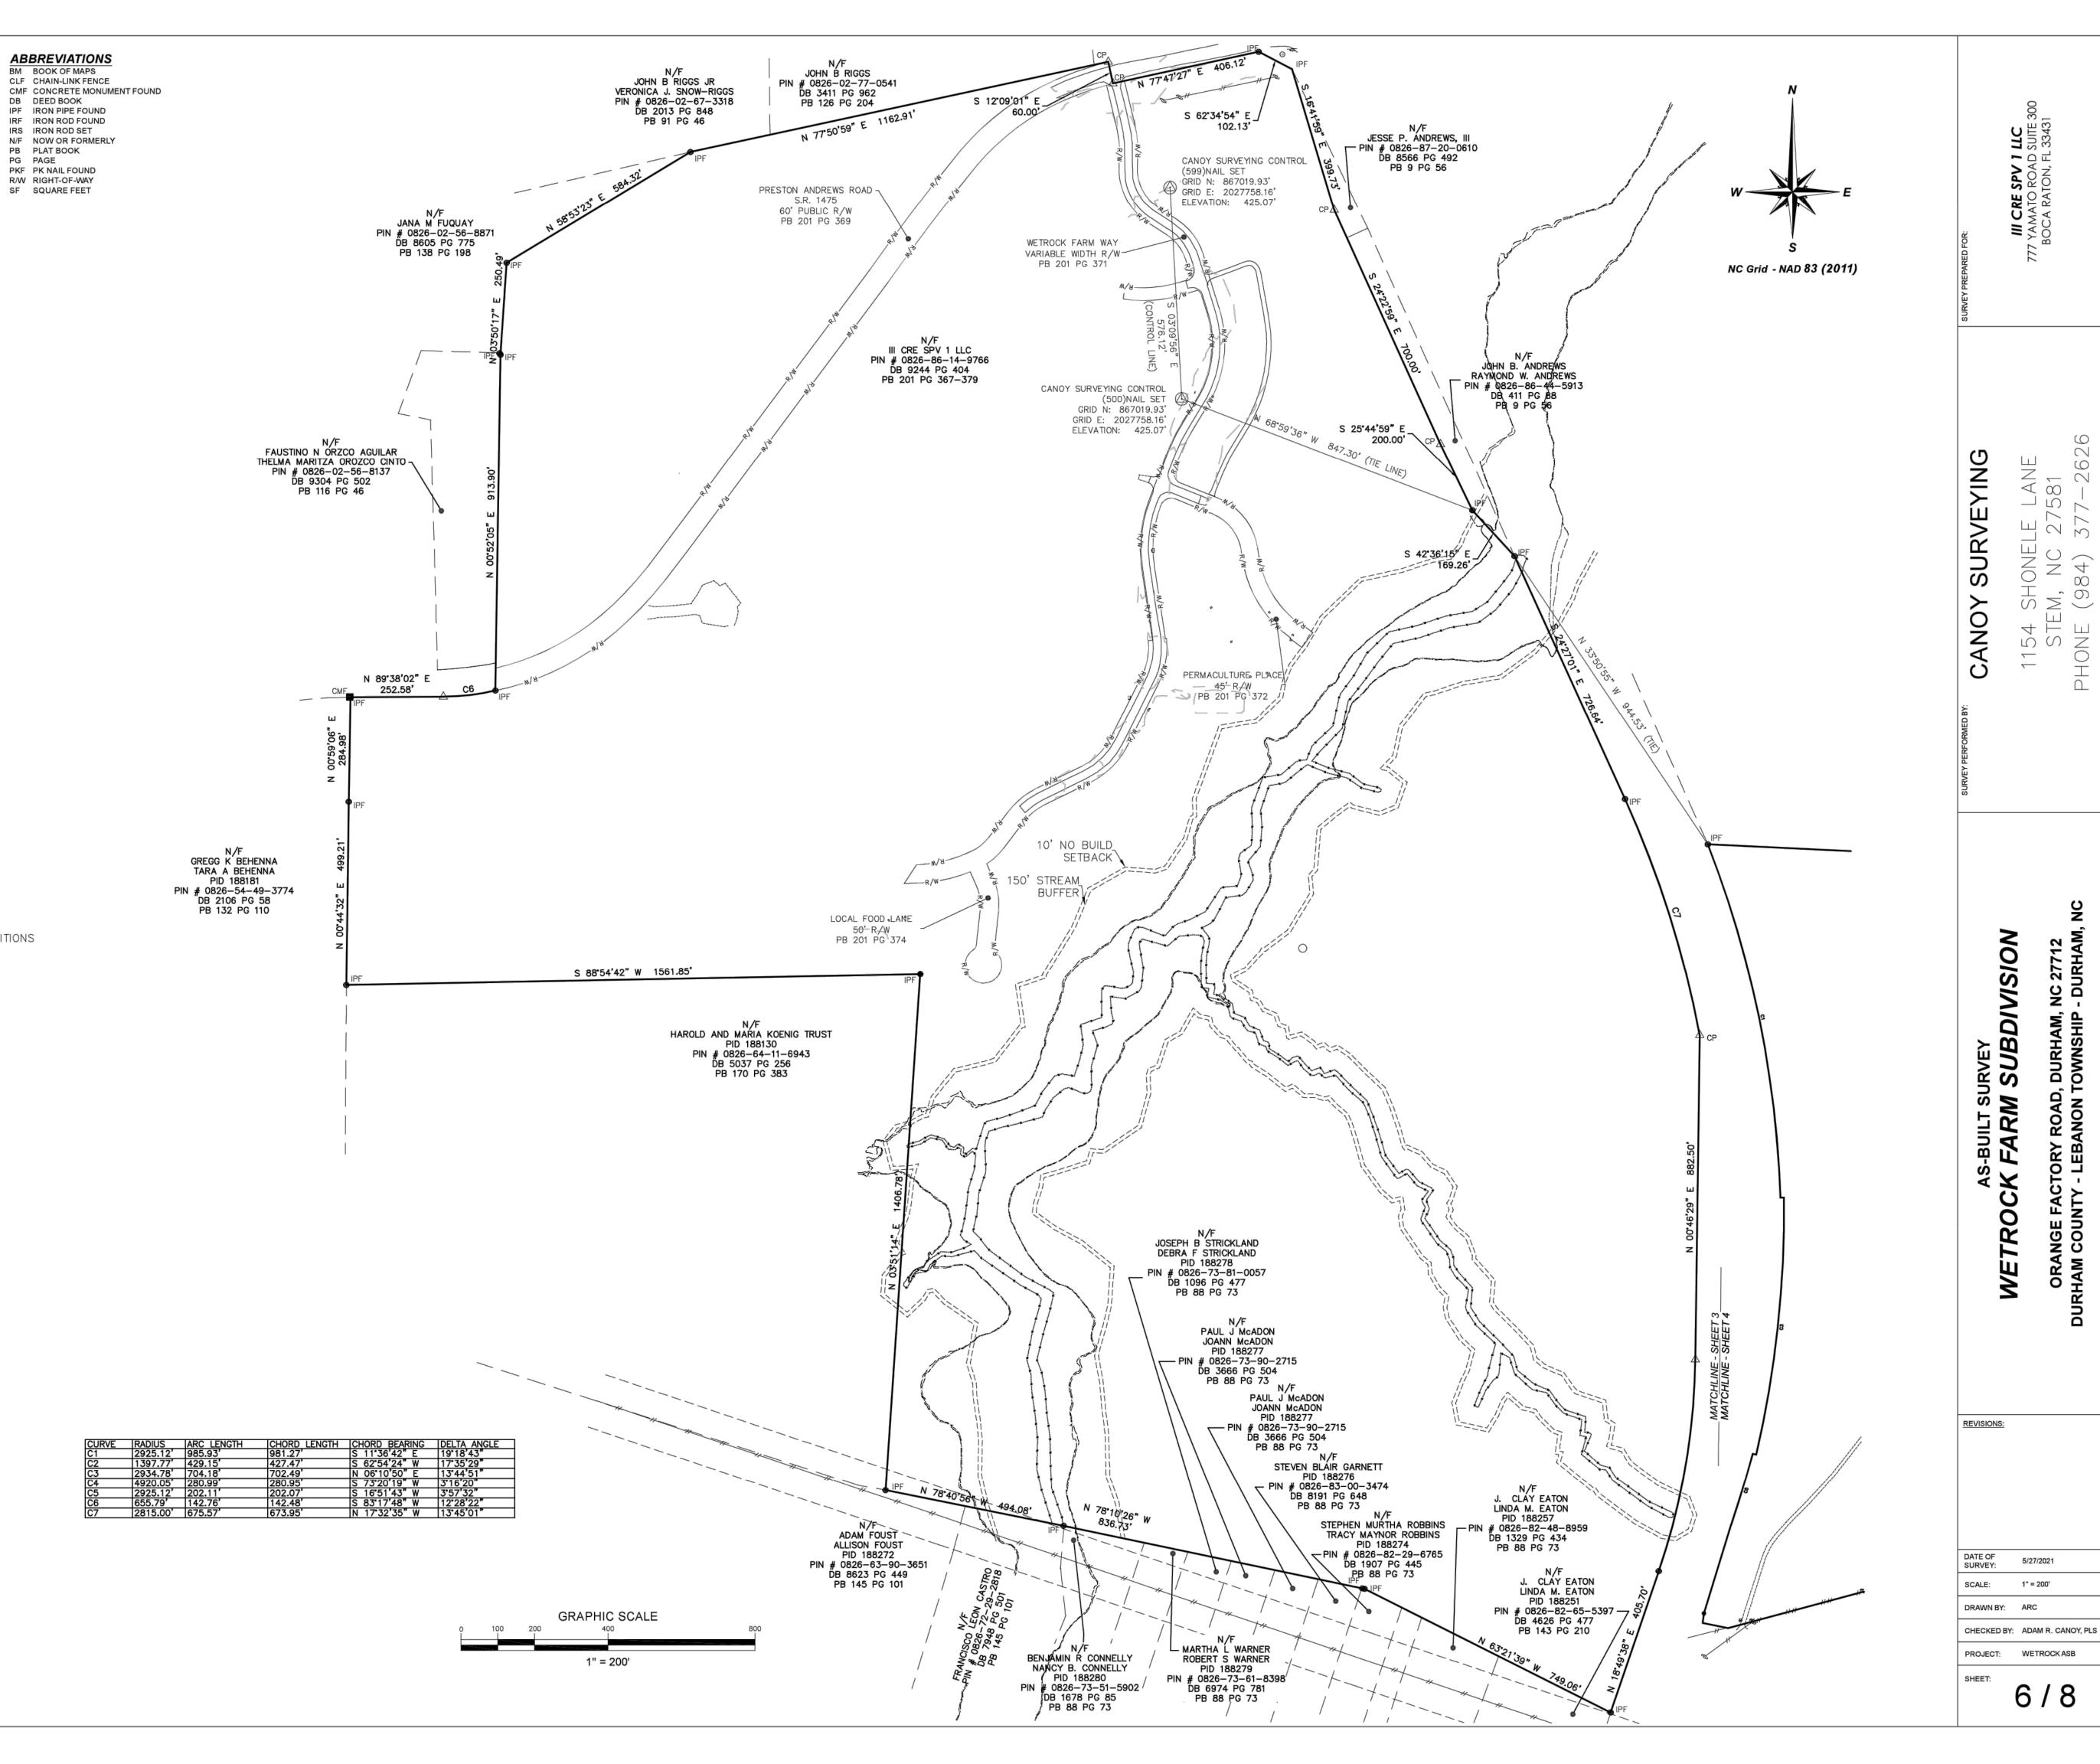

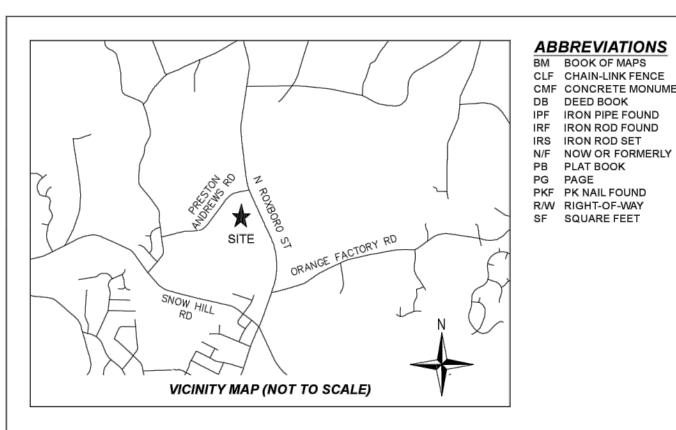

GENERAL NOTES

1) THE PURPOSE OF THIS PLAT IS A BOUNDARY SURVEY OF THE PROPERTY LINES SHOWN.

2) CANOY SURVEYINGS TASK WAS SURVEY THE BOUNDARY OF THE LARGE SUBJECT PARCEL. INTERNAL LOT LINES, ROAD RIGHT OF WAYS, AND EXISTING EASEMENTS EXIST FROM PREVIOUS SUBDIVISION AS SHOWN IN PB 201 PG 367-379 BUT ARE SUBJECT TO CHANGE.

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5) ALL DISTANCES AND COORDINATES SHOWN HEREON ARE LOCALIZED, GROUND INFORMATION, UNLESS SPECIFICALLY NOTED AS "GRID".

LEGEND

	BOUNDARY WIRE FENCE GRAVEL EDGE OF WATER STORM DRAIN PIPE PAVEMENT MINOR CONTOUR MAJOR CONTOUR OVERHEAD ELECTRIC LINE RIPRAP DIRT PATH (SEE NOTE 6) FLOOD ZONE 1% FUTURE CONDITIONS FLOOD ZONE AE TOP OF BANK BOLLARD
	ELECTRIC CONTROL BOX
Φ	ELEC METER
•	PROPERTY MONUMENT

© PLASTIC MANHOLE LID

→ TV PEDESTAL W WATER METER

₩ATER VALVE

■ CURB INLET

C LIT POLE

SANITARY CLEAN OUT

1 ELECTRIC TRANSFORMER

FIBER HANDHOLE


FIBER OPTIC VAULT


MAILBOX

♥ UTILITY POLE ⊸ SIGN

W DRILLED WELLS (SEE NOTE 6) GAS TANK

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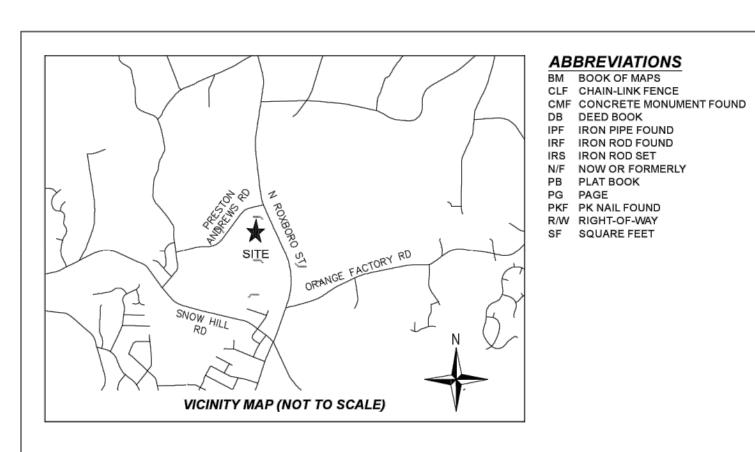


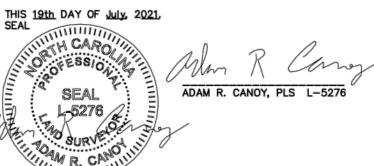III CRE SPV 1 LLC 7 YAMATO ROAD SUIT BOCA RATON, FL 334

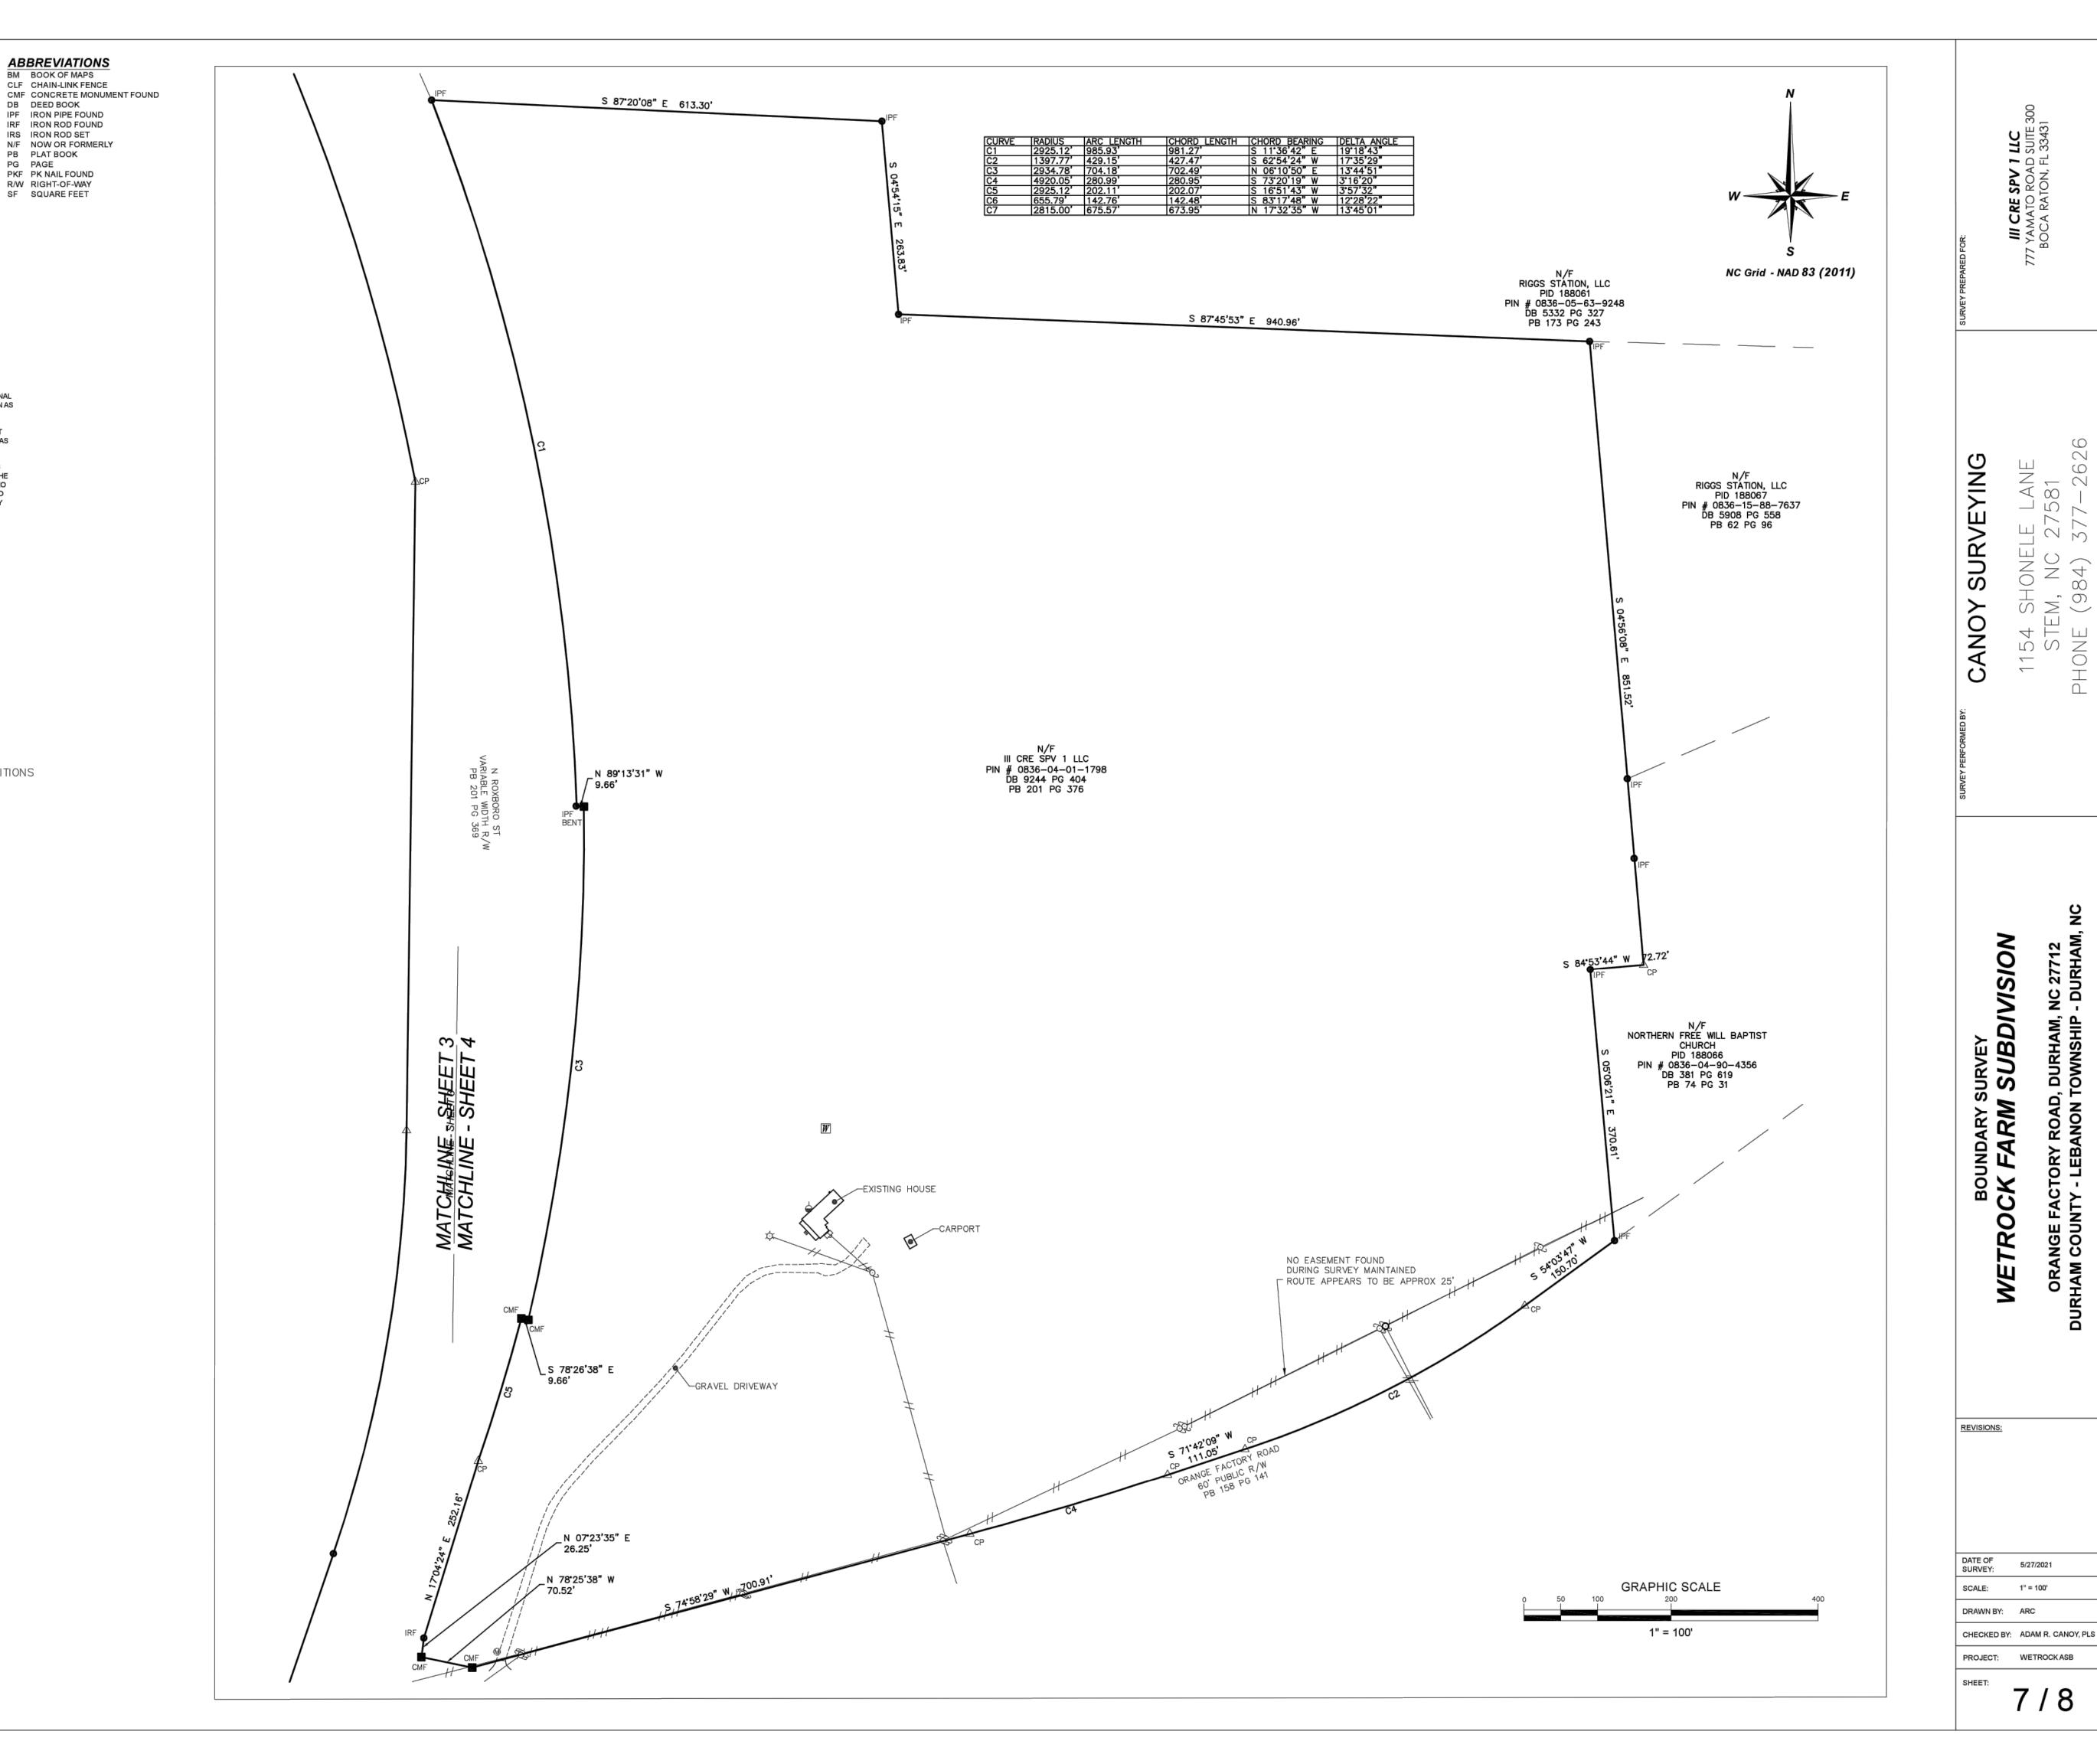HONELE LANE 1, NC 27581 984) 377-2626


1154 S-PHONE


TRO



GENERAL NOTES 1) THE PURPOSE OF THIS PLAT IS A BOUNDARY SURVEY OF THE PROPERTY LINES SHOWN.

- 2) CANOY SURVEYINGS TASK WAS SURVEY THE BOUNDARY OF THE LARGE SUBJECT PARCEL. INTERNAL LOT LINES, ROAD RIGHT OF WAYS, AND EXISTING EASEMENTS EXIST FROM PREVIOUS SUBDIVISION AS SHOWN IN PB 201 PG 367-379 BUT ARE SUBJECT TO CHANGE.
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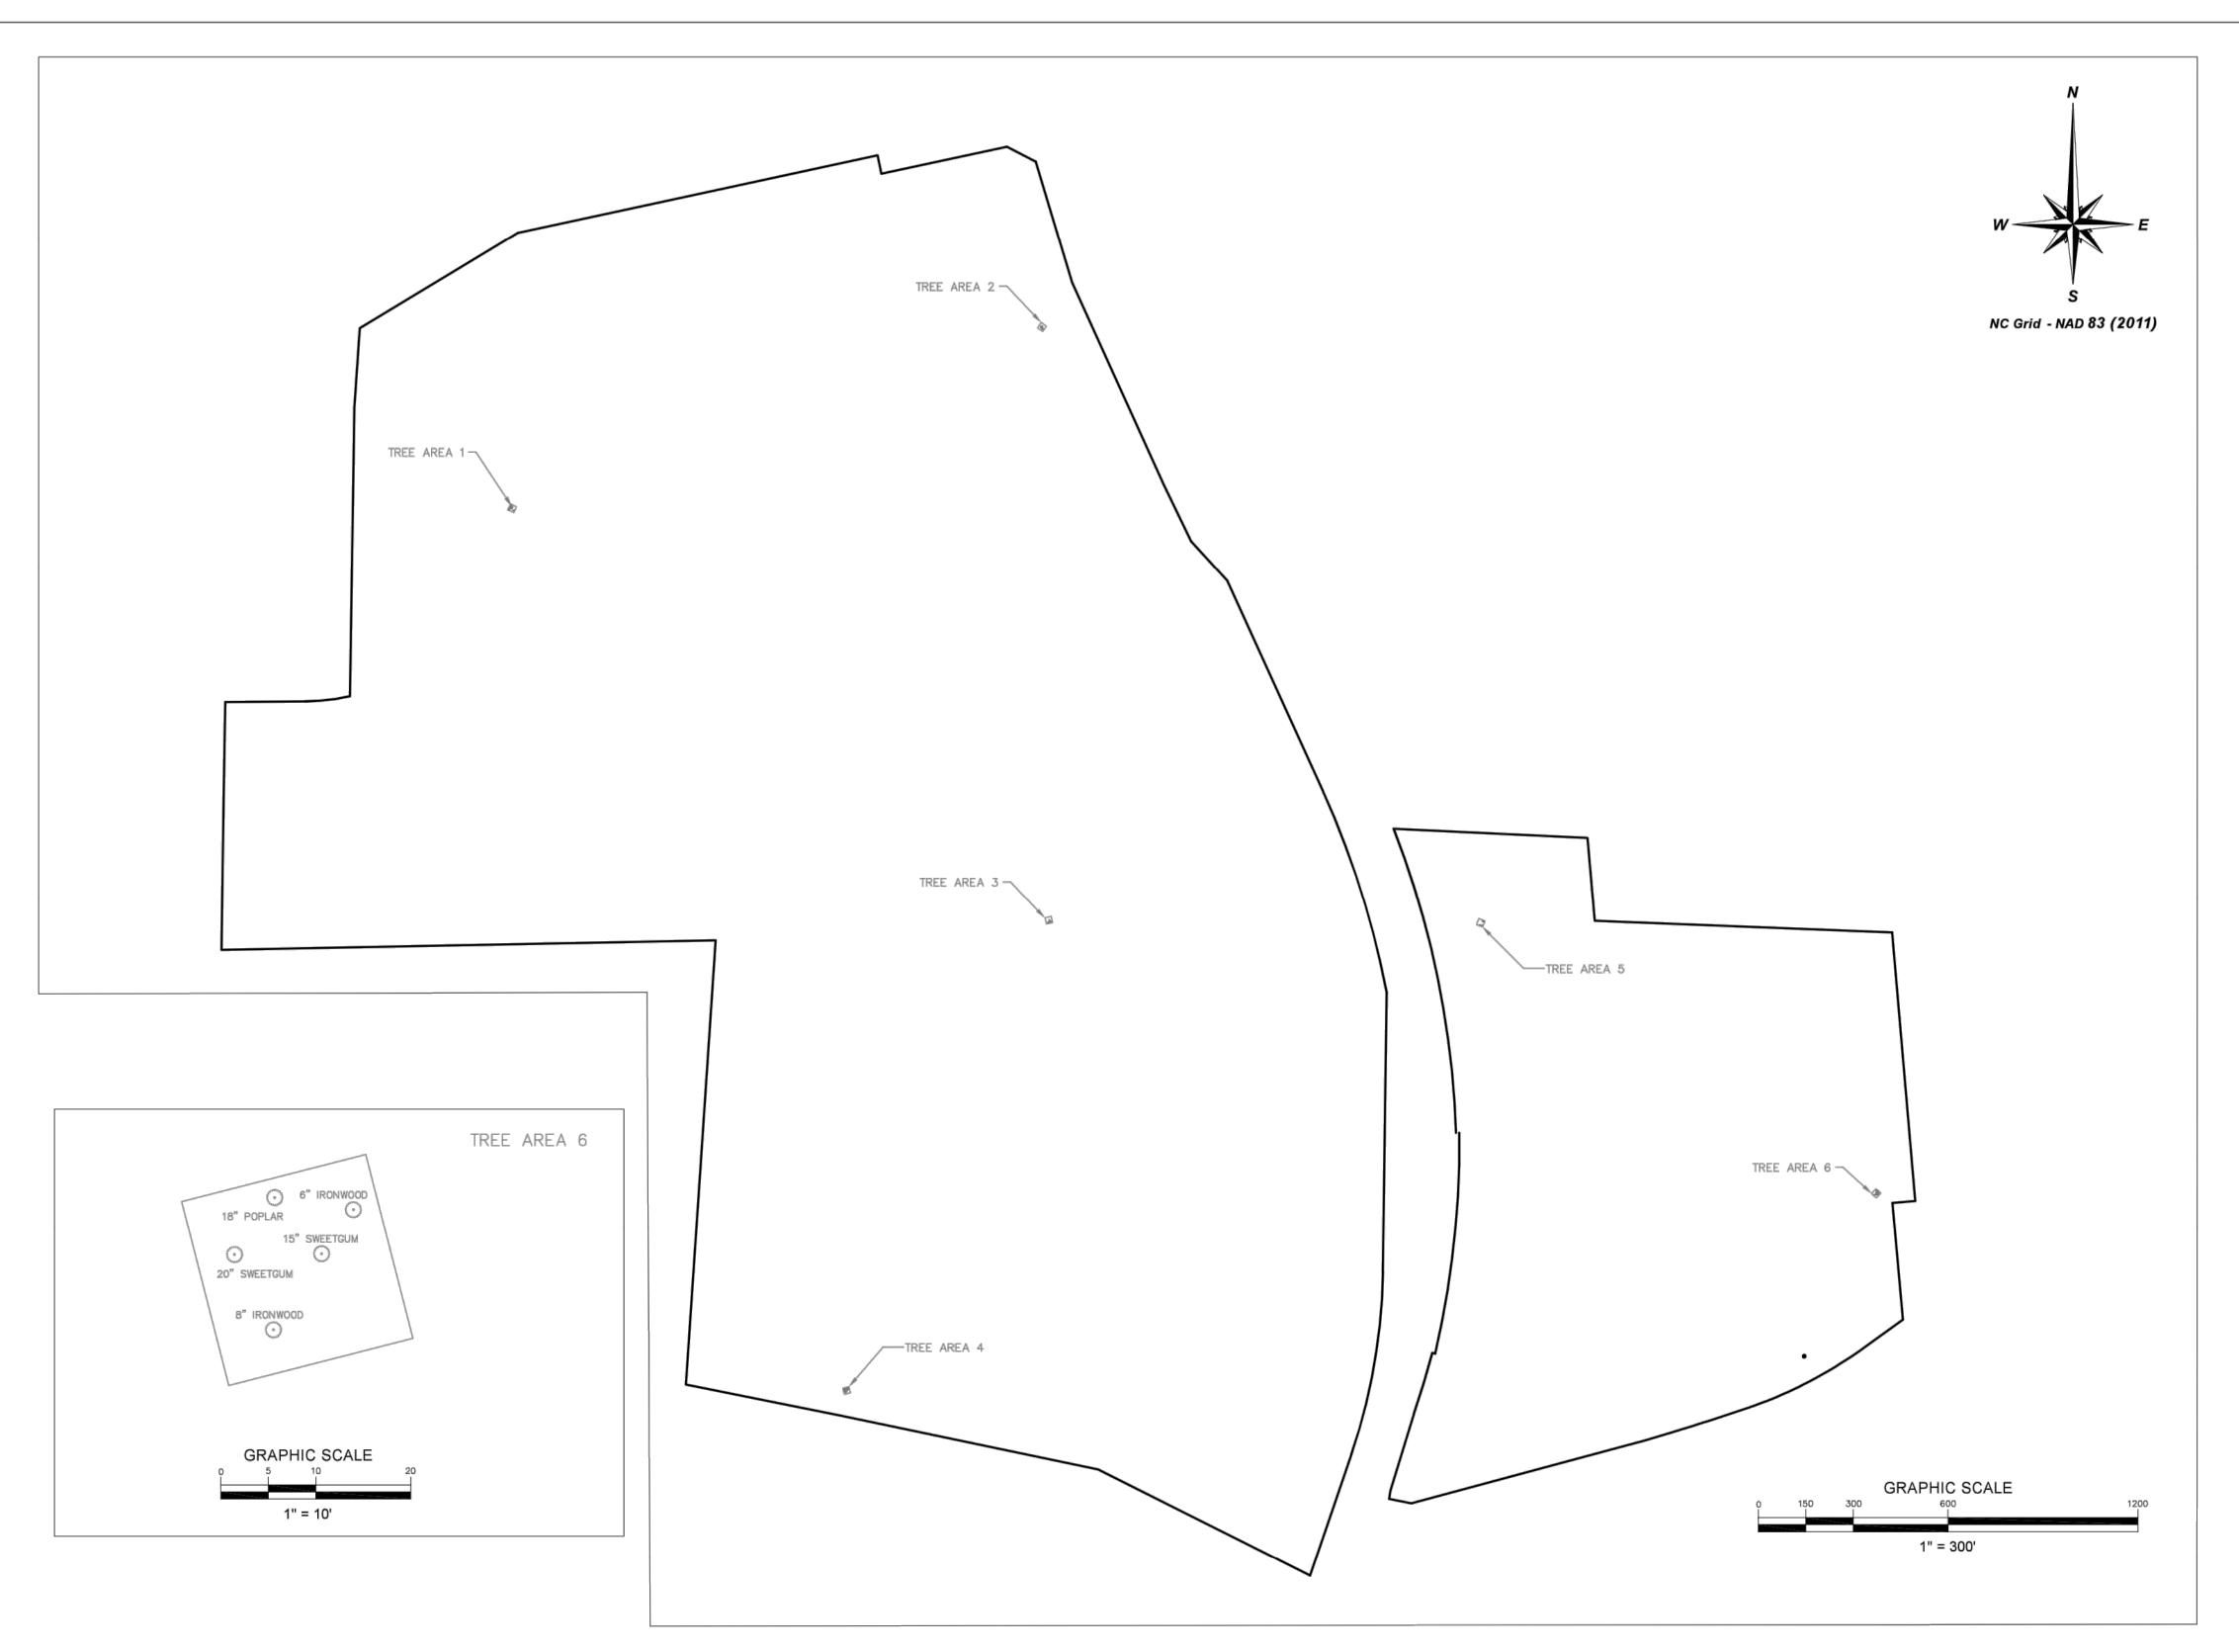


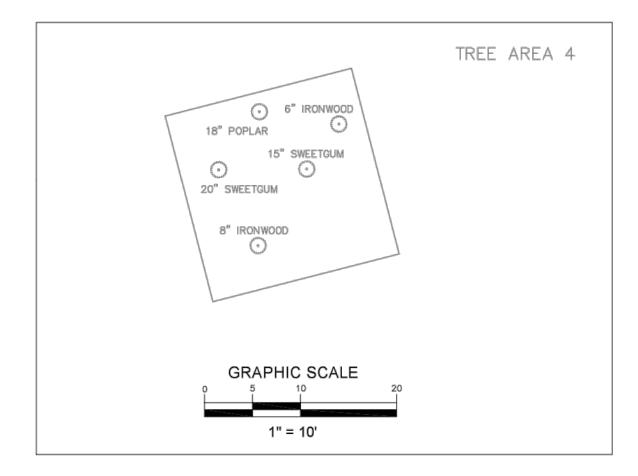


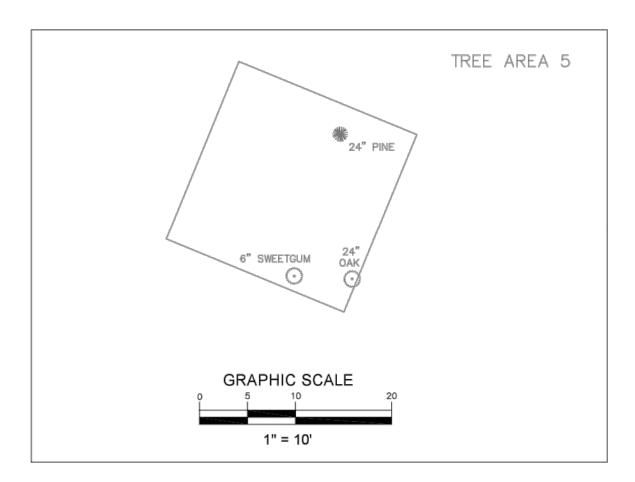
I CERTIFY THAT THIS PROJECT WAS COMPLETED UNDER MY SUPERVISION FROM AN ACTUAL SURVEY MADE UNDER MY SUPERVISION; THAT THIS GROUND SURVEY WAS PERFORMED AT THE 95% CONFIDENCE LEVEL TO MEET FEDERAL GEOGRAPHIC DATA COMMITTEE STANDARDS; THAT THIS SURVEY WAS PERFORMED TO MEET THE REQUIREMENTS FOR A TOPOGRAPHIC/PLANIMETRIC SURVEY TO THE ACCURACY OF CLASS A STANDARD AND VERTICAL ACCURACY WHEN APPLICABLE TO THE CLASS A STANDARD, AND THAT THE ORIGINAL DATA WAS OBTAINED ON 7/11/21; THAT THE SURVEY WAS COMPLETED ON 7/11/21; THAT CONTOURS SHOWN MAY NOT MEET THE STATED STANDARD; AND ALL COORDINATES ARE BASED ON 'NAD 83' AND REALIZATION (2011) AND ALL ELEVATIONS ARE BASED ON NAVD 88 GEOID 12B.


ADAM R. CANOY, PLS L-5276





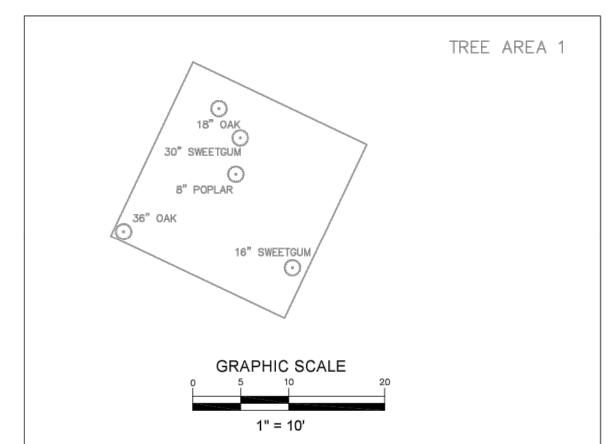

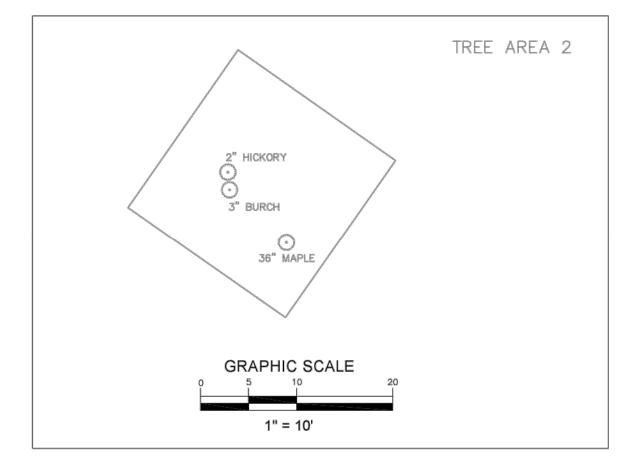

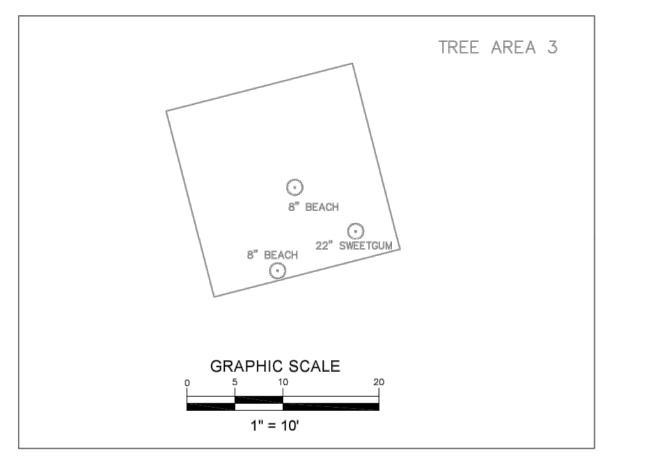

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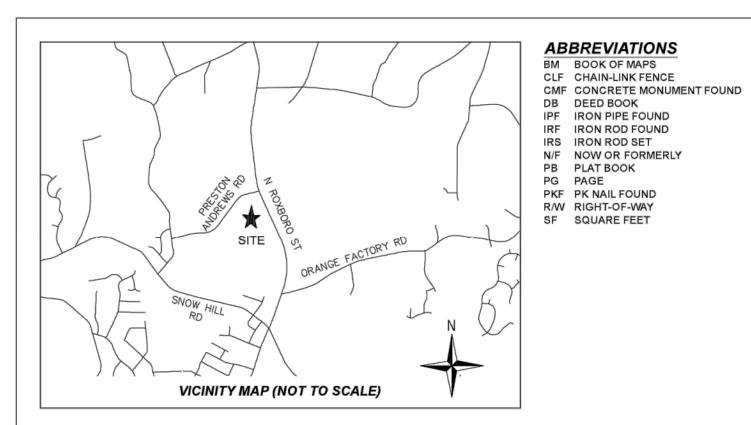
CANOY

TROCK FARM SUBDIVISION ORANGE FACTORY ROAD, DURHAM, DURHAM COUNTY - LEBANON TOWNSHIP

REVISIONS:

DATE OF SURVEY: 5/27/2021 SCALE: 1" = 300' DRAWN BY: ARC

CHECKED BY: ADAM R. CANOY, PLS PROJECT: WETROCK ASB



GENERAL NOTES


1) THE PURPOSE OF THIS PLAT IS A BOUNDARY SURVEY OF THE PROPERTY LINES SHOWN.


2) CANOY SURVEYINGS TASK WAS SURVEY THE BOUNDARY OF THE LARGE SUBJECT PARCEL. INTERNAL LOT LINES, ROAD RIGHT OF WAYS, AND EXISTING EASEMENTS EXIST FROM PREVIOUS SUBDIVISION AS SHOWN IN PB 201 PG 367-379 BUT ARE SUBJECT TO CHANGE.

3) PROPERTIES SHOWN HEREON ARE SUBJECT TO EASEMENTS AND RESTRICTIONS OF RECORD THAT WOULD BE REVEALED BY A THOROUGH TITLE SEARCH. THIS PLAT SHOULD NOT BE RELIED UPON AS A COMPLETE RECORD OF ALL EASEMENTS THAT MAY EFFECT THESE PROPERTIES.

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5) ALL DISTANCES AND COORDINATES SHOWN HEREON ARE LOCALIZED, GROUND INFORMATION, UNLESS SPECIFICALLY NOTED AS "GRID".



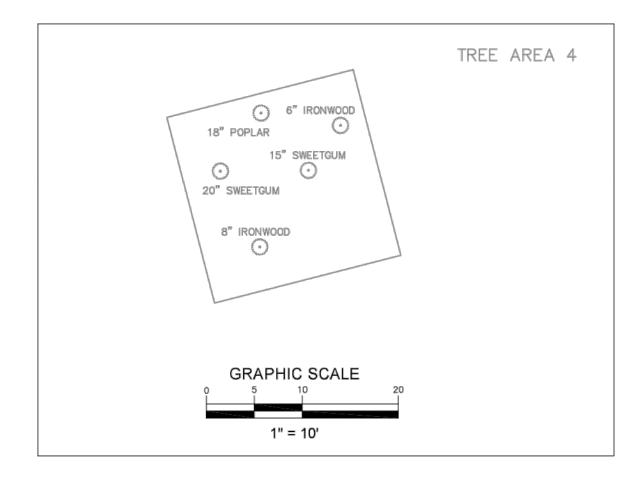

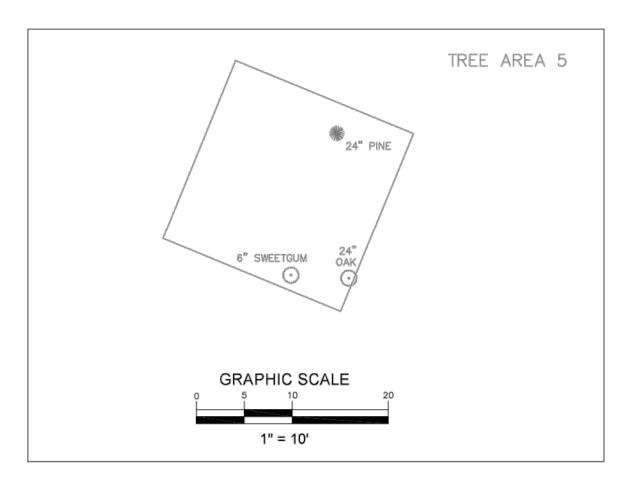
I CERTIFY THAT THIS PROJECT WAS COMPLETED UNDER MY SUPERVISION FROM AN ACTUAL SURVEY MADE UNDER MY SUPERVISION; THAT THIS GROUND SURVEY WAS PERFORMED AT THE 95% CONFIDENCE LEVEL TO MEET FEDERAL GEOGRAPHIC DATA COMMITTEE STANDARDS; THAT THIS SURVEY WAS PERFORMED TO MEET THE REQUIREMENTS FOR A TOPOGRAPHIC/PLANIMETRIC SURVEY TO THE ACCURACY OF CLASS A STANDARD AND VERTICAL ACCURACY WHEN APPLICABLE TO THE CLASS A STANDARD, AND THAT THE ORIGINAL DATA WAS OBTAINED ON 7/11/21; THAT THE SURVEY WAS COMPLETED ON 7/11/21; THAT CONTOURS SHOWN MAY NOT MEET THE STATED STANDARD; AND ALL COORDINATES ARE BASED ON 'NAD 83' AND REALIZATION (2011) AND ALL ELEVATIONS ARE BASED ON NAVD 88 GEOID 12B.


THIS <u>19th</u> DAY OF <u>July,</u> 2<u>021</u>. SEAL


ADAM R. CANOY, PLS L-5276





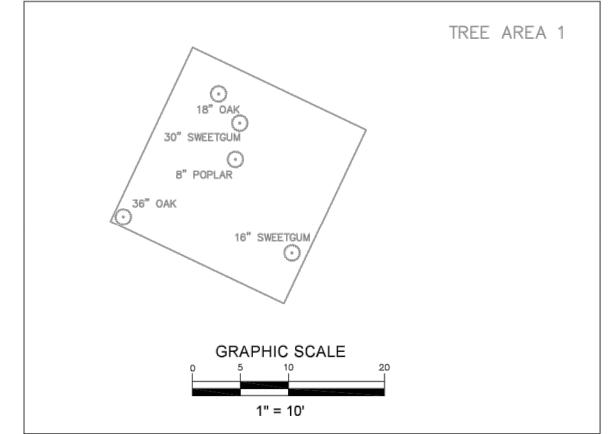

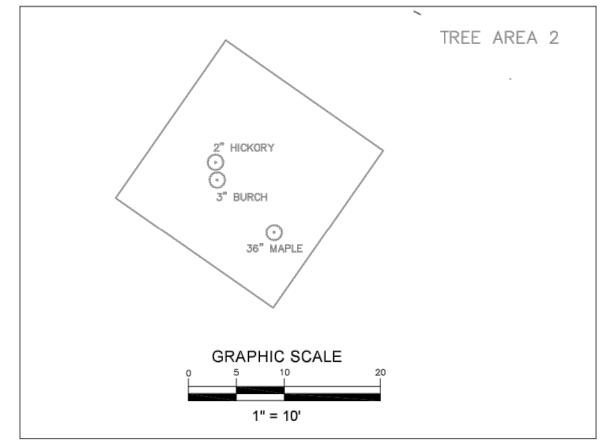

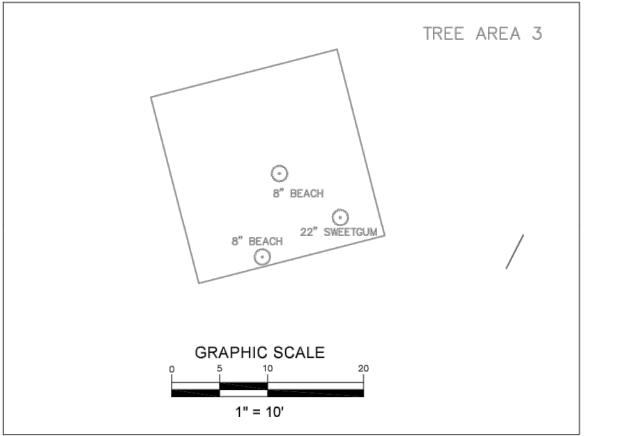

LANE 7581 7-2626

CANOY 1154 SH STEM, PHONE (9

, NC 27712 - DURHAM, TREE SURVEY
WETROCK FARM SUBDIVISION ORANGE FACTORY ROAD, DURHAM, DURHAM COUNTY - LEBANON TOWNSHIP


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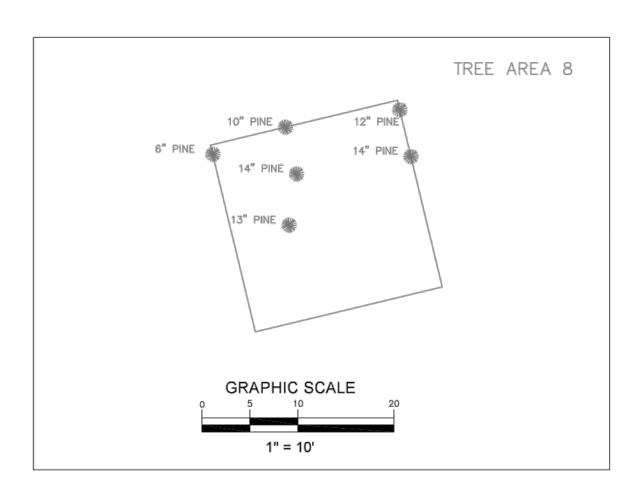
DATE OF SURVEY: 5/27/2021 SCALE: 1" = 300' DRAWN BY: ARC

CHECKED BY: ADAM R. CANOY, PLS PROJECT: WETROCKASB

GENERAL NOTES

- 1) THE PURPOSE OF THIS PLAT IS A BOUNDARY SURVEY OF THE PROPERTY LINES SHOWN.
- 2) CANOY SURVEYINGS TASK WAS SURVEY THE BOUNDARY OF THE LARGE SUBJECT PARCEL. INTERNAL LOT LINES, ROAD RIGHT OF WAYS, AND EXISTING EASEMENTS EXIST FROM PREVIOUS SUBDIVISION AS SHOWN IN PB 201 PG 367-379 BUT ARE SUBJECT TO CHANGE.
- 3) PROPERTIES SHOWN HEREON ARE SUBJECT TO EASEMENTS AND RESTRICTIONS OF RECORD THAT WOULD BE REVEALED BY A THOROUGH TITLE SEARCH. THIS PLAT SHOULD NOT BE RELIED UPON AS A COMPLETE RECORD OF ALL EASEMENTS THAT MAY EFFECT THESE PROPERTIES.
- 4) THIS MAP DOES NOT REPRESENT A BOUNDARY SURVEY. PROPERTY LINES, STREAM CENTERLINES AND PLANIMETRIC INFORMATION SHOWN HEREON WERE TAKEN FROM CAD FILES PROVIDED BY THE CLIENT; AND THIS INFORMATION HAS BEEN SHOWN HEREON FOR REFERENCE PURPOSES ONLY. NO TRANSLATION, ROTATION OR SCALING WAS PERFORMED ON THE GIS DATA. IT WAS INSERTED INTO OUR DRAWING FILE AS PROVIDED. NO ACCURACY OR POSITIONAL TOLERANCE IS GUARANTEED BY THIS SURVEY AS TO HOW THE SURVEYED FEATURES TRULY RELATE TO THE GIS INFORMATION
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ADAM R. CANOY, PLS L-5276



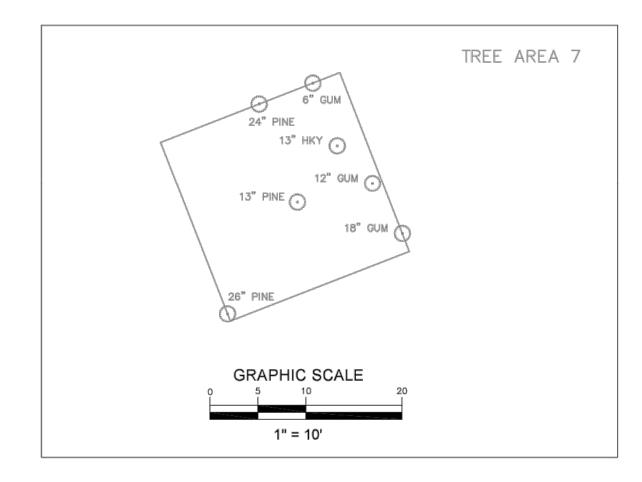



10" GUM

18" GUM

18" GUM ① ① 16" POP

GRAPHIC SCALE

1" = 10'

O_{8" POP}


○_{18" HKY}

1" = 10'

O_{8" POP} O_{24" POP}

TREE AREA 9

TREE AREA 10

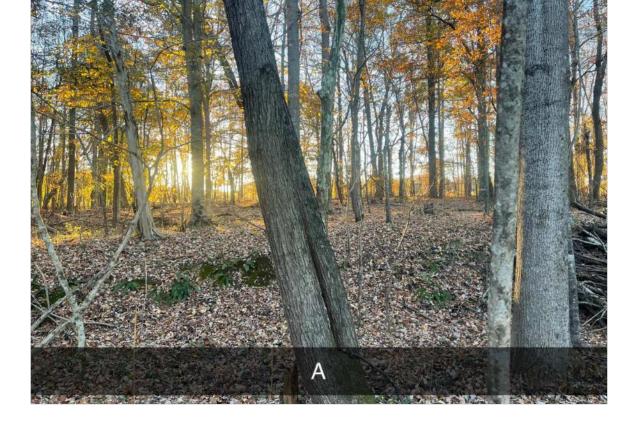










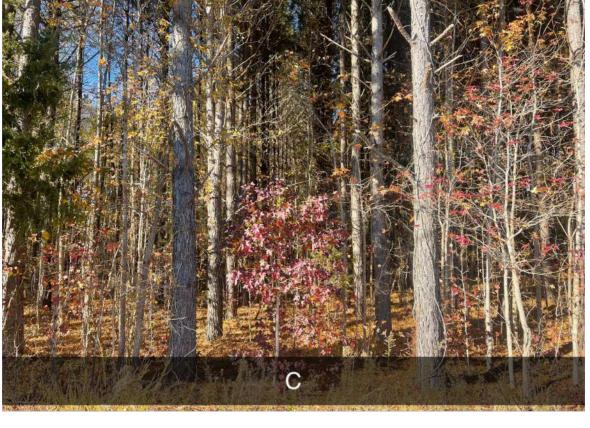


TREE AREA 8



TREE AREA 7





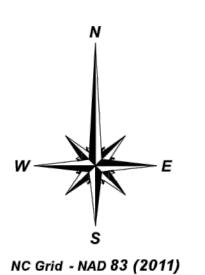

NE 11 262 LA 758

TREE SURVEY
FARM SUBDIVISION

S TRO


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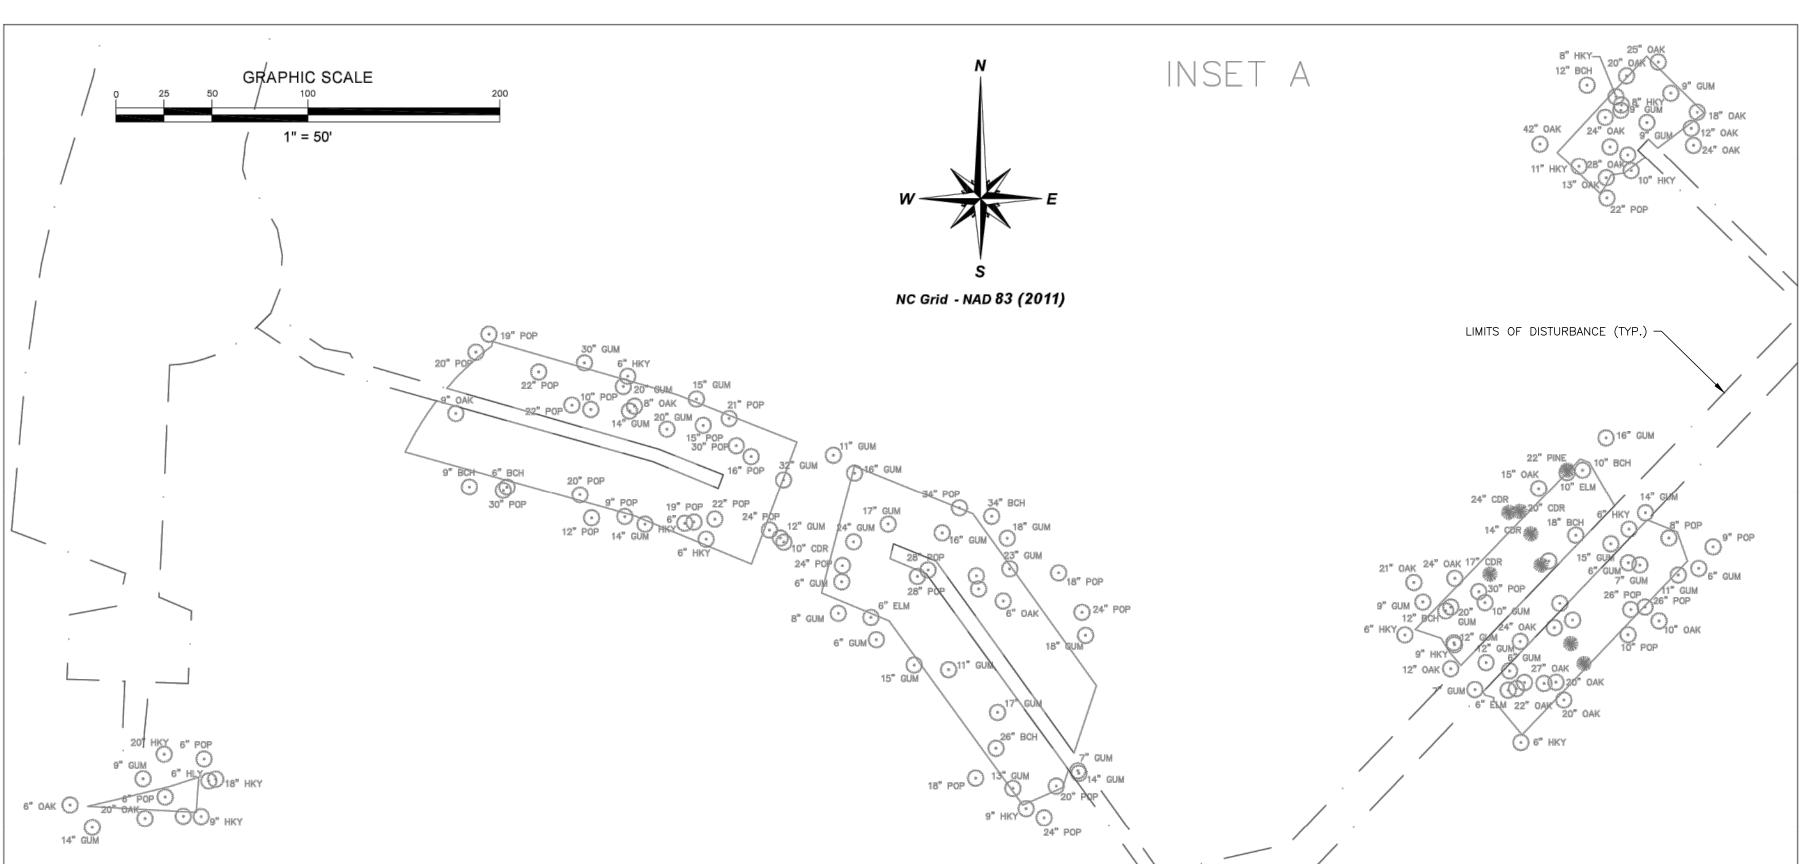
5/27/2021 SCALE: 1" = 300'


DRAWN BY: ARC CHECKED BY: ADAM R. CANOY, PLS PROJECT: WETROCKASB

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THIS <u>19th</u> DAY OF <u>July</u>, 2<u>021</u>, SEAL

ADAM R. CANOY, PLS L-5276

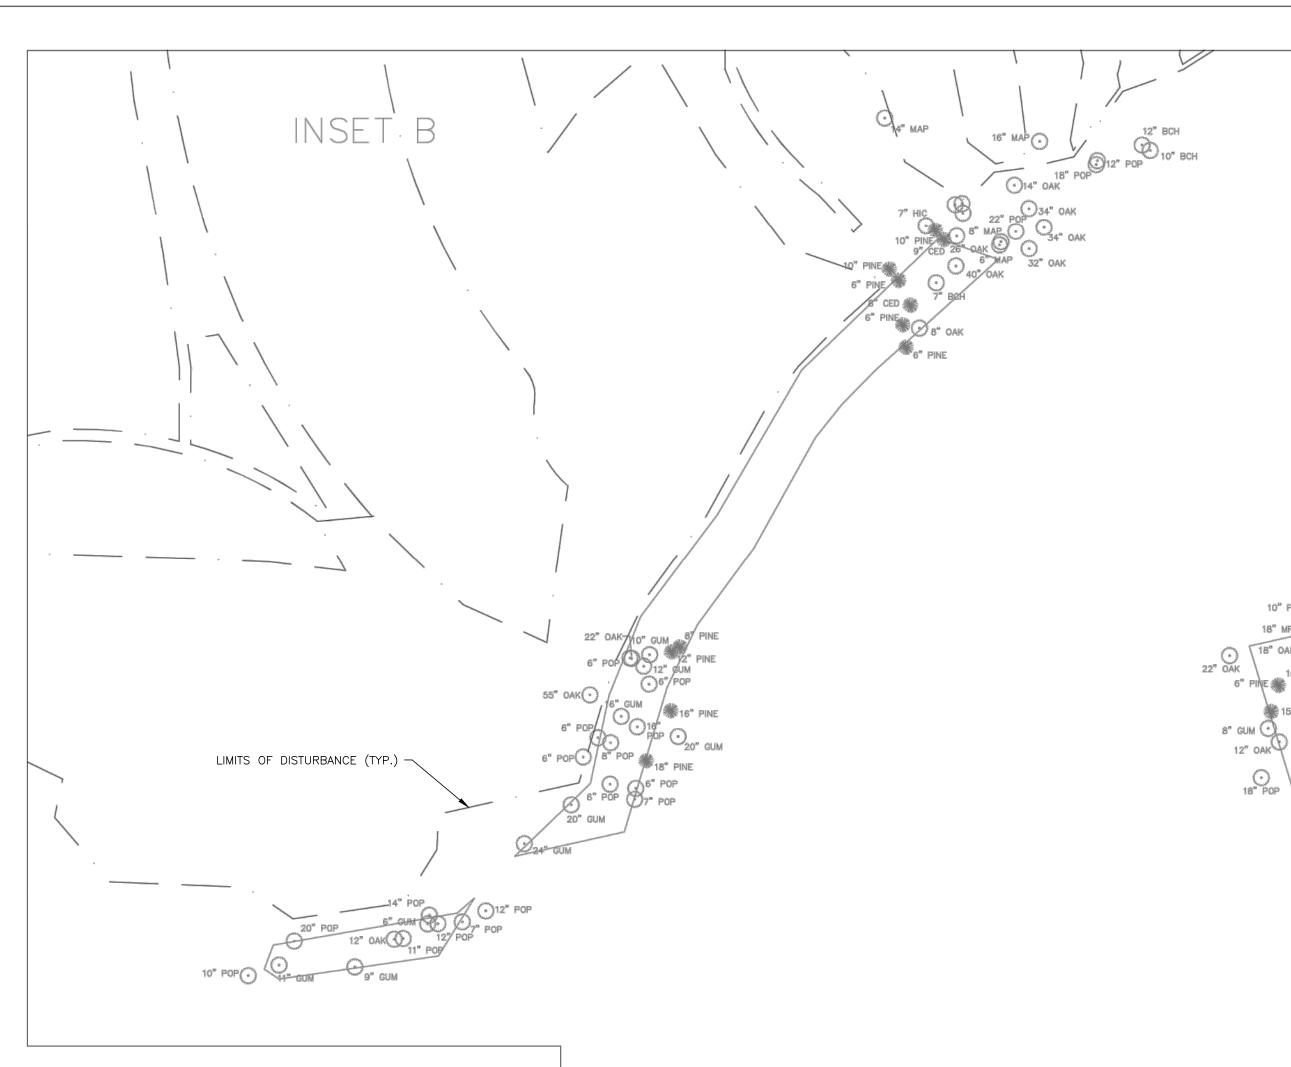

TREE SURVEY
WETROCK FARM SUBDIVISION

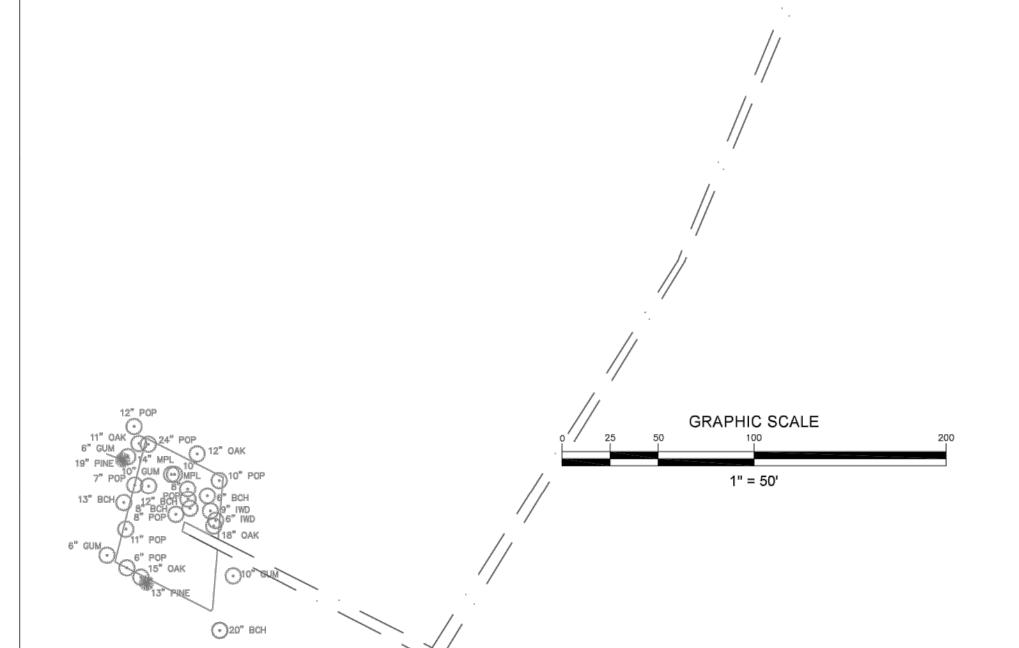LANE 7581 7-2626

1154 STE PHONE

CANOY

NC Grid - NAD 83 (2011)

REVISIONS:

DATE OF 5/27/2021

SCALE: 1" = 300'

DRAWN BY: ARC

DRAWN BY: ARC

CHECKED BY: ADAM R. CANOY, PLS

PROJECT: WETROCK ASB



